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IDI Logistics

IDI Logistics

840 Apollo street, Suite 343
El Segundo, CA 90245
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Project: ERRIS LOGISTIC CENTER SOUTH

MAPES ST. & A ST.
PERRIS, CA

	CIVIL	THIENE
	STRUCTURAL	
	MECHANICAL	
	PLUMBING	
	ELECTRICAL	GREG
	LANDSCAPE	
	FIRE PROTECTION	RL
	SOILS ENGINEER	

Title: OVERALL FENCE PLAN

Project Number: 19214
Drawn by: CR
Date: 07/16/21
Revision:

OVERALL FENCE PLAN

scale: 1" = 150'-0"

A

SCALE: 1" = 150'-0"

TRUE



| EGFND

SITE PLAN KEYNOTES

-   1 14'H CONCRETE TILT-UP SCREEN WALL
 -  2 8' HIGH WROUGHT IRON FENCE.
 -   3 PROPOSED 8' HIGH METAL SLIDING GATE.
 -   4 PROPOSED 8' HIGH METAL SWING GATE.
 -   5 14' HIGH WROUGHT IRON FENCE WITH METAL MASH

This architectural drawing shows a fence section spanning 103'-3". The fence is labeled as '14'H METAL FENCE WITH METAL MASH'. A vertical dimension line indicates a height of 14'. On the left side, there is a vertical column of five fence panels, each labeled 'TYP. 5'. On the right side, there is a vertical column of four fence panels, each labeled 'TYP. 1'. The total length of the fence is 103'-3", and there are 20' sections on either side of the main fence run.

PARTIAL SCREENWALL & FENCE ELEVATION

Shee

DAB-A1.1A



FIRE KEYNOTES

- 1 FIRE LANE IDENTIFICATION – RED CURB.
 - 2 FIRE LANE ENTRANCE SIGN.
 - 3 FIRE LANE NO PARKING SIGN.
 - 4 MANUAL GATE WITH KNOX PADLOCK AND FIRE LANE NO-PARKING SIGN (11/AD.5) IF GATE CHANGES TO ELECTRONIC GATES, PROVIDE A KONX EMERGENCY OVERRIDE KEY SWITCH (WITH DUST COVER.)
 - 5 FIRE HYDRANT
 - 6 FIRE DEPARTMENT CONNECTION (FDC)
 - 7 BOLLARD.
 - 8 KONX BOX AT BUILDING ENTRANCE OR GATE PER FIRE DEPARTMENT
 - 9 FIRE POST INDICATOR VALVE (PIV)

PERRIS FIRE DEPARTMENT ACCESS AND WATER NOTES


INSPECTION REQUIREMENTS

- 1 PERRIS SITE INSPECTIONS ARE REQUIRED FOR THIS PROJECT. PLEASE SCHEDULE ALL FIELD INSPECTIONS AT LEAST 48HRS IN ADVANCE. INSPECTIONS CANCELED AFTER 1P, ON THE DAY BEFORE THE SCHEDULED DATE WILL BE SUBJECT TO A RE-INSPECTION FEE. CALL (951) 443-10299 TO SCHEDULE AN INSPECTION
 2. A LUMBER DROP INSPECTION SHALL BE PERFORMED PRIOR TO BRINGING COMBUSTIBLE MATERIALS (OR COMBUSTIBLE FIXTURES AND FINISHED FOR STRUCTURES OF NON-COMBUSTIBLE CONSTRUCTION). ALL-WEATHER ACCESS ROADS CAPABLE OF SUPPORTING 68,000LBS., TOPPED WITH ASPHALT, CONCRETE, OR EQUIVALENT SHALL BE IN PLACE AND HYDRANTS OPERATIONAL AT TIME OF LUMBER DROP INSPECTION.
 3. FOR PROJECTS WITH FUEL MODIFICATION, A VEGETATION CLEARANCE INSPECTION IS REQUIRED PRIOR TO A LUMBER DROP INSPECTION. USE THE FUEL MODIFICATION PLAN SERVICE REQUEST NUMBER TO SCHEDULE THE VEGETATION CLEARANCE INSPECTION.
 4. PHASED INSTALLATION OF FIRE ACCESS ROADS REQUIRES ADDITIONAL INSPECTIONS NOT COVERED BY THE FEES PAID AT PLAN SUBMITTALS. CONTACT (951) 443-1029 TO ARRANGE FOR ADDITIONAL INSPECTIONS THAT MAY BE NEEDED AND ANY FEES THAT MAY BE DUE.
 5. AN ORIGINAL APPROVED, SIGNED, WET-STAMPED PERRIS FIRE ACCESS & WATER PLAN SHALL BE AVAILABLE ON-SITE AT TIME OF INSPECTION.
 6. ACCESS ROADS AND HYDRANTS SHALL BE MAINTAINED AND REMAIN CLEAR OF OBSTRUCTIONS AT ALL TIMES DURING AND AFTER CONSTRUCTION. AREAS WHERE PARKING IS NOT PERMITTED SHALL BE CLEARLY IDENTIFIED AT ALL TIMES. OBSTRUCTIONS OF FIRE LANES AND HYDRANTS MAY RESULT IN CANCELLATION OR SUSPENSION OF INSPECTIONS.
 7. TEMPORARY FUEL TANKS OF 60 OR MORE GALLONS SHALL BE REVIEWED, INSPECTED, AND PERMITTED BY THE OFFICE OF THE FIRE MARSHAL, CITY OF PERRIS PRIOR TO USE.
 8. THE PROJECT ADDRESS SHALL BE CLEARLY POSTED AND VISIBLE FROM THE PUBLIC ROAD DURING CONSTRUCTION.
 9. ALL GATES IN CONSTRUCTION FENCING SHALL BE EQUIPPED WITH EITHER A KNOX OR BREAKAWAY PADLOCK.
 10. BUILDING OF FOUR OR MORE STORIES SHALL BE PROVIDED WITH STAIRS AND A STANDPIPE BEFORE REACHING 40 FEET IN HEIGHT.
GENERAL REQUIREMENTS
 11. FIRE LANE WIDTHS SHALL BE MEASURED FROM TOP FACE OF THE CURB TO TOP FACE OF THE CURB FOR FIRE LANES WITH STANDARD CURBS AND GUTTERS AND FROM FLOW-LINE TO FLOW-LINE FOR FIRE LANES WITH MODIFIED CURB DESIGNS (E.G., ROLLED, RAMPED, ETC). THE DEVELOPER IS RESPONSIBLE TO VERIFY THAT ALL APPROVED PUBLIC WORKS OR GRADING DEPARTMENT STREET IMPROVEMENT PLANS OR PRECISE GRADING PLANS CONFORM TO THE MINIMUM STREET WIDTH MEASUREMENTS PER THE APPROVED PERRIS FIRE DEPARTMENT ACCESS & WATER PLAN AND STANDARDS IDENTIFIED IN PERRIS FIRE DEPARTMENT ACCESS & WATER GUIDELINE FOR ALL PORTIONS OF THE FIRE ACCESS ROADS

NOTE:
FIRE ACCESS ROADWAYS SHALL BE DESIGNED, CONSTRUCTED AND MAINTAINED TO SUPPORT THE IMPOSED LOADS OF PERRIS FIRE APPARATUS WITH A TOTAL WEIGHT OF 68,000 POUNDS. APPARATUS WEIGHT IS DISTRIBUTED AS 46,000 POUNDS ON TANDEM REAR AXLES AND 22,000 POUNDS ON THE FRONT AXLE. THE SURFACE SHALL BE DESIGNED, CONSTRUCTED, AND MAINTAINED TO PROVIDE ALL-WEATHER DRIVING CAPABILITIES. A LETTER OR STATEMENT, WET-STAMPED AND SIGNED BY A REGISTERED ENGINEER, SHALL BE PROVIDED ON THE PLANS CERTIFYING THAT ANY NEW ROADWAY MEETS THIS 68,000-POUNDS, ALL WEATHER REQUIREMENT. ROAD BASE WITHOUT AN APPROPRIATE TOPPING OR BINDING MATERIAL DOES NOT SATISFY THE ALL-WEATHER REQUIREMENT.

SITE LEGEND

	LANDSCAPED AREA		LIGHT STANDARD		STANDARD PARKING STALL (9' X 19')	C.B.	CATCH BASIN, APPROX. LOCATION. SEE CIVIL DRWGS.
	PAVING - SEE "C" DWGS. FOR THICKNESS		EXISTING PUBLIC FIRE HYDRANT		HANDICAP PARKING STALL (9' X 19')		
	CONCRETE PAVING SEE "C" DWGS. FOR THICKNESS		PRIVATE FIRE HYDRANT- APPROXIMATE LOCATION F.H.				
	PROPERTY LINE		FIRE LANE 26'		PATH OF TRAVEL		
					8'H WROUGHT IRON FENCE		

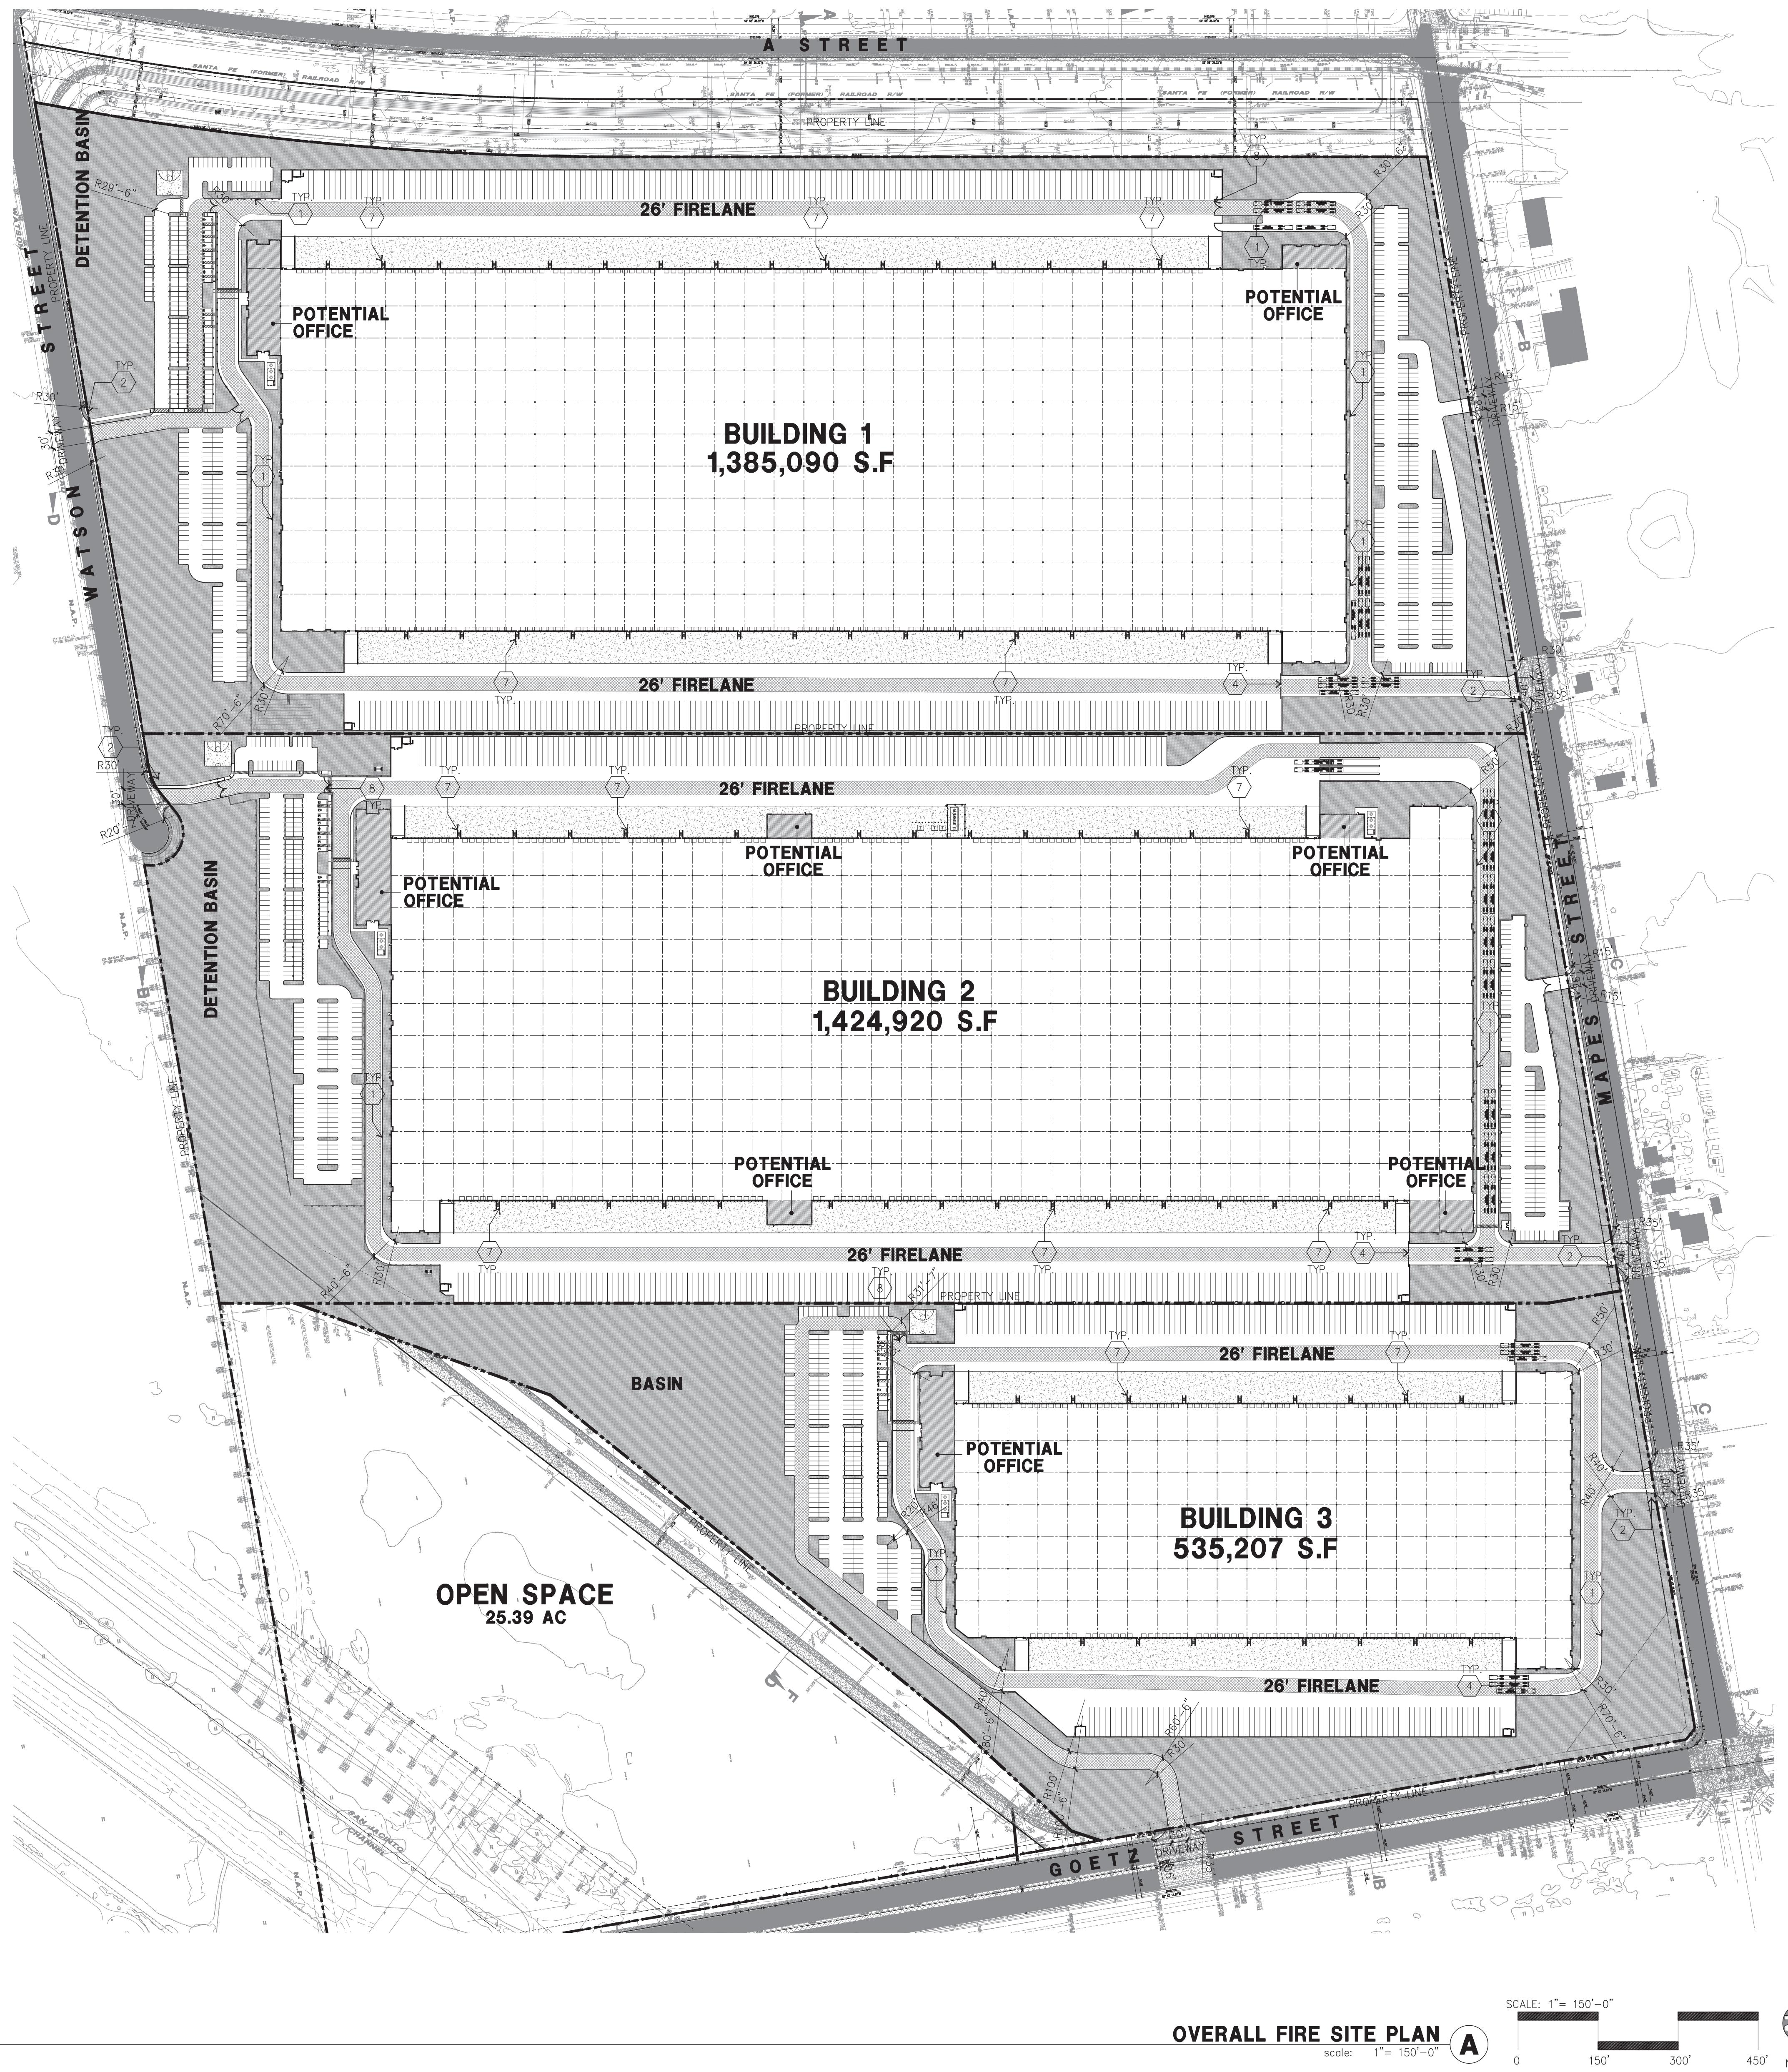

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10 Apollo street, Suite 343
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The image features a solid black square centered at the top. Below it, the word "Project:" is written in a large, serif font. Underneath "Project:", the text "PERRIS LOGISTIC CENTER" is displayed in a large, bold, sans-serif font. At the bottom, the words "SOUTH" are written in a smaller, all-caps, sans-serif font.

MAPES ST. & A ST.
PERRIS, CA

CIVIL	THIENES
STRUCTURAL	-
MECHANICAL	-
PLUMBING	-
ELECTRICAL	GREGG
LANDSCAPE	RLA
FIRE PROTECTION	-
SOILS ENGINEER	-

Title: FIRE DEPARTMENT ACCESS PLAN

Project Number: 19214

Drawn by: CR

Date: 07/16/21

Sheet:

DAB-A1.1F



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Project:
PERRIS LOGISTIC CENTER
SOUTH

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PERRIS, CA


Consultants:

CIVIL	THIENES
STRUCTURAL	
MECHANICAL	
PLUMBING	
ELECTRICAL	
LANDSCAPE	
FIRE PROTECTION	
SOILS ENGINEER	

Title: FIRE SITE PLAN

Project Number: 19214
Drawn by: CR
Date: 07/16/21
Revision:

Sheet: DAB-A1.1S

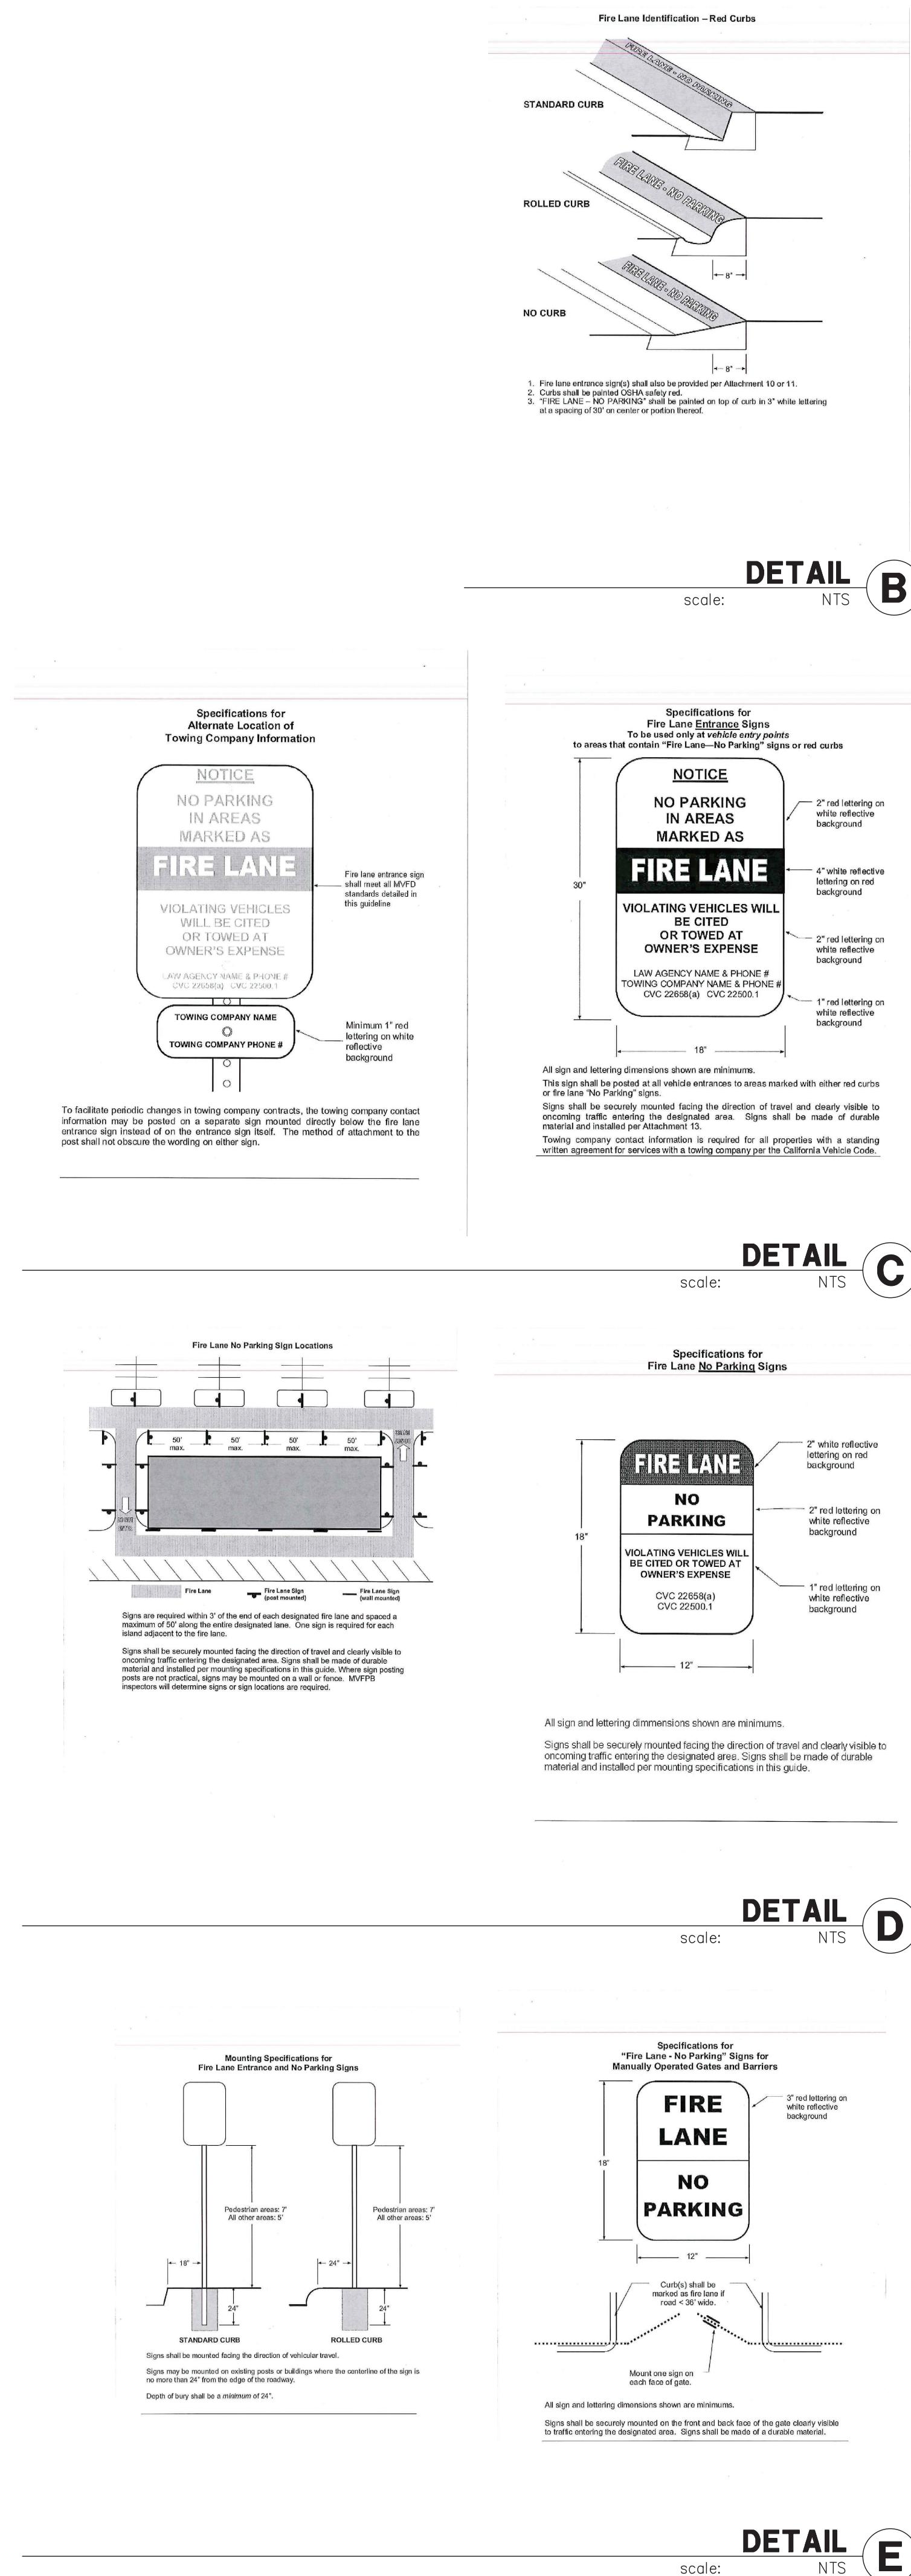


SITE LEGEND

LANDSCAPED AREA	O - □ LIGHT STANDARD	STANDARD PARKING STALL (9' x 19')	C.B. CATCH BASIN, APPROX. LOCATION SEE CIVIL DRWGS.
PAVING - SEE "C" DWGS. FOR THICKNESS	EXISTING PUBLIC FIRE HYDRANT	HANDICAP PARKING STALL (9' x 19')	
CONCRETE PAVING SEE "C" DWGS. FOR THICKNESS	PRIVATE FIRE HYDRANT- APPROXIMATE LOCATION		
PROPERTY LINE	PATH OF TRAVEL	TRAIL/MAINTENANCE ROAD	
	FIRE LANE 26'		

FIRE KEYNOTES

- (1) FIRE LANE IDENTIFICATION - RED CURB.
- (2) FIRE LANE ENTRANCE SIGN.
- (3) FIRE LANE NO PARKING SIGN.
- (4) MANUAL GATE WITH KNOX PADLOCK AND FIRE LANE NO-PARKING SIGN (11/A.D.5) IF GATE CHANGES TO ELECTRONIC GATES, PROVIDE A KONX EMERGENCY OVERRIDE KEY SWITCH (WITH DUST COVER.)
- (5) FIRE HYDRANT
- (6) FIRE DEPARTMENT CONNECTION (FDC)
- (7) BOLLARD.
- (8) KONX BOX AT BUILDING ENTRANCE OR GATE PER FIRE DEPARTMENT
- (9) FIRE POST INDICATOR VALVE (PIV)

NOTE: FIRE ACCESS ROADWAYS SHALL BE DESIGNED, CONSTRUCTED AND MAINTAINED TO SUPPORT THE IMPOSED LOADS OF PERRIS FIRE APPARATUS WITH A TOTAL WEIGHT OF 68,000 POUNDS. APPARATUS WEIGHT IS DISTRIBUTED AS 46,000 POUNDS ON TANDEM REAR AXLES AND 22,000 POUNDS ON THE FRONT AXLE. THE ROADWAY SHALL BE DESIGNED, CONSTRUCTED AND MAINTAINED TO PROVIDE ALL-WEATHER DRIVING CAPABILITIES. A LETTER OR STATEMENT, WET-STAMPED AND SIGNED BY A REGISTERED ENGINEER, SHALL BE PROVIDED ON THE PLANS CERTIFYING THAT ANY NEW ROADWAY MEETS THIS 68,000 POUND ALL-WEATHER REQUIREMENT. ROAD BASE WITHOUT AN APPROPRIATE TOPPING OR BINDING MATERIAL DOES NOT SATISFY THE ALL-WEATHER REQUIREMENT.

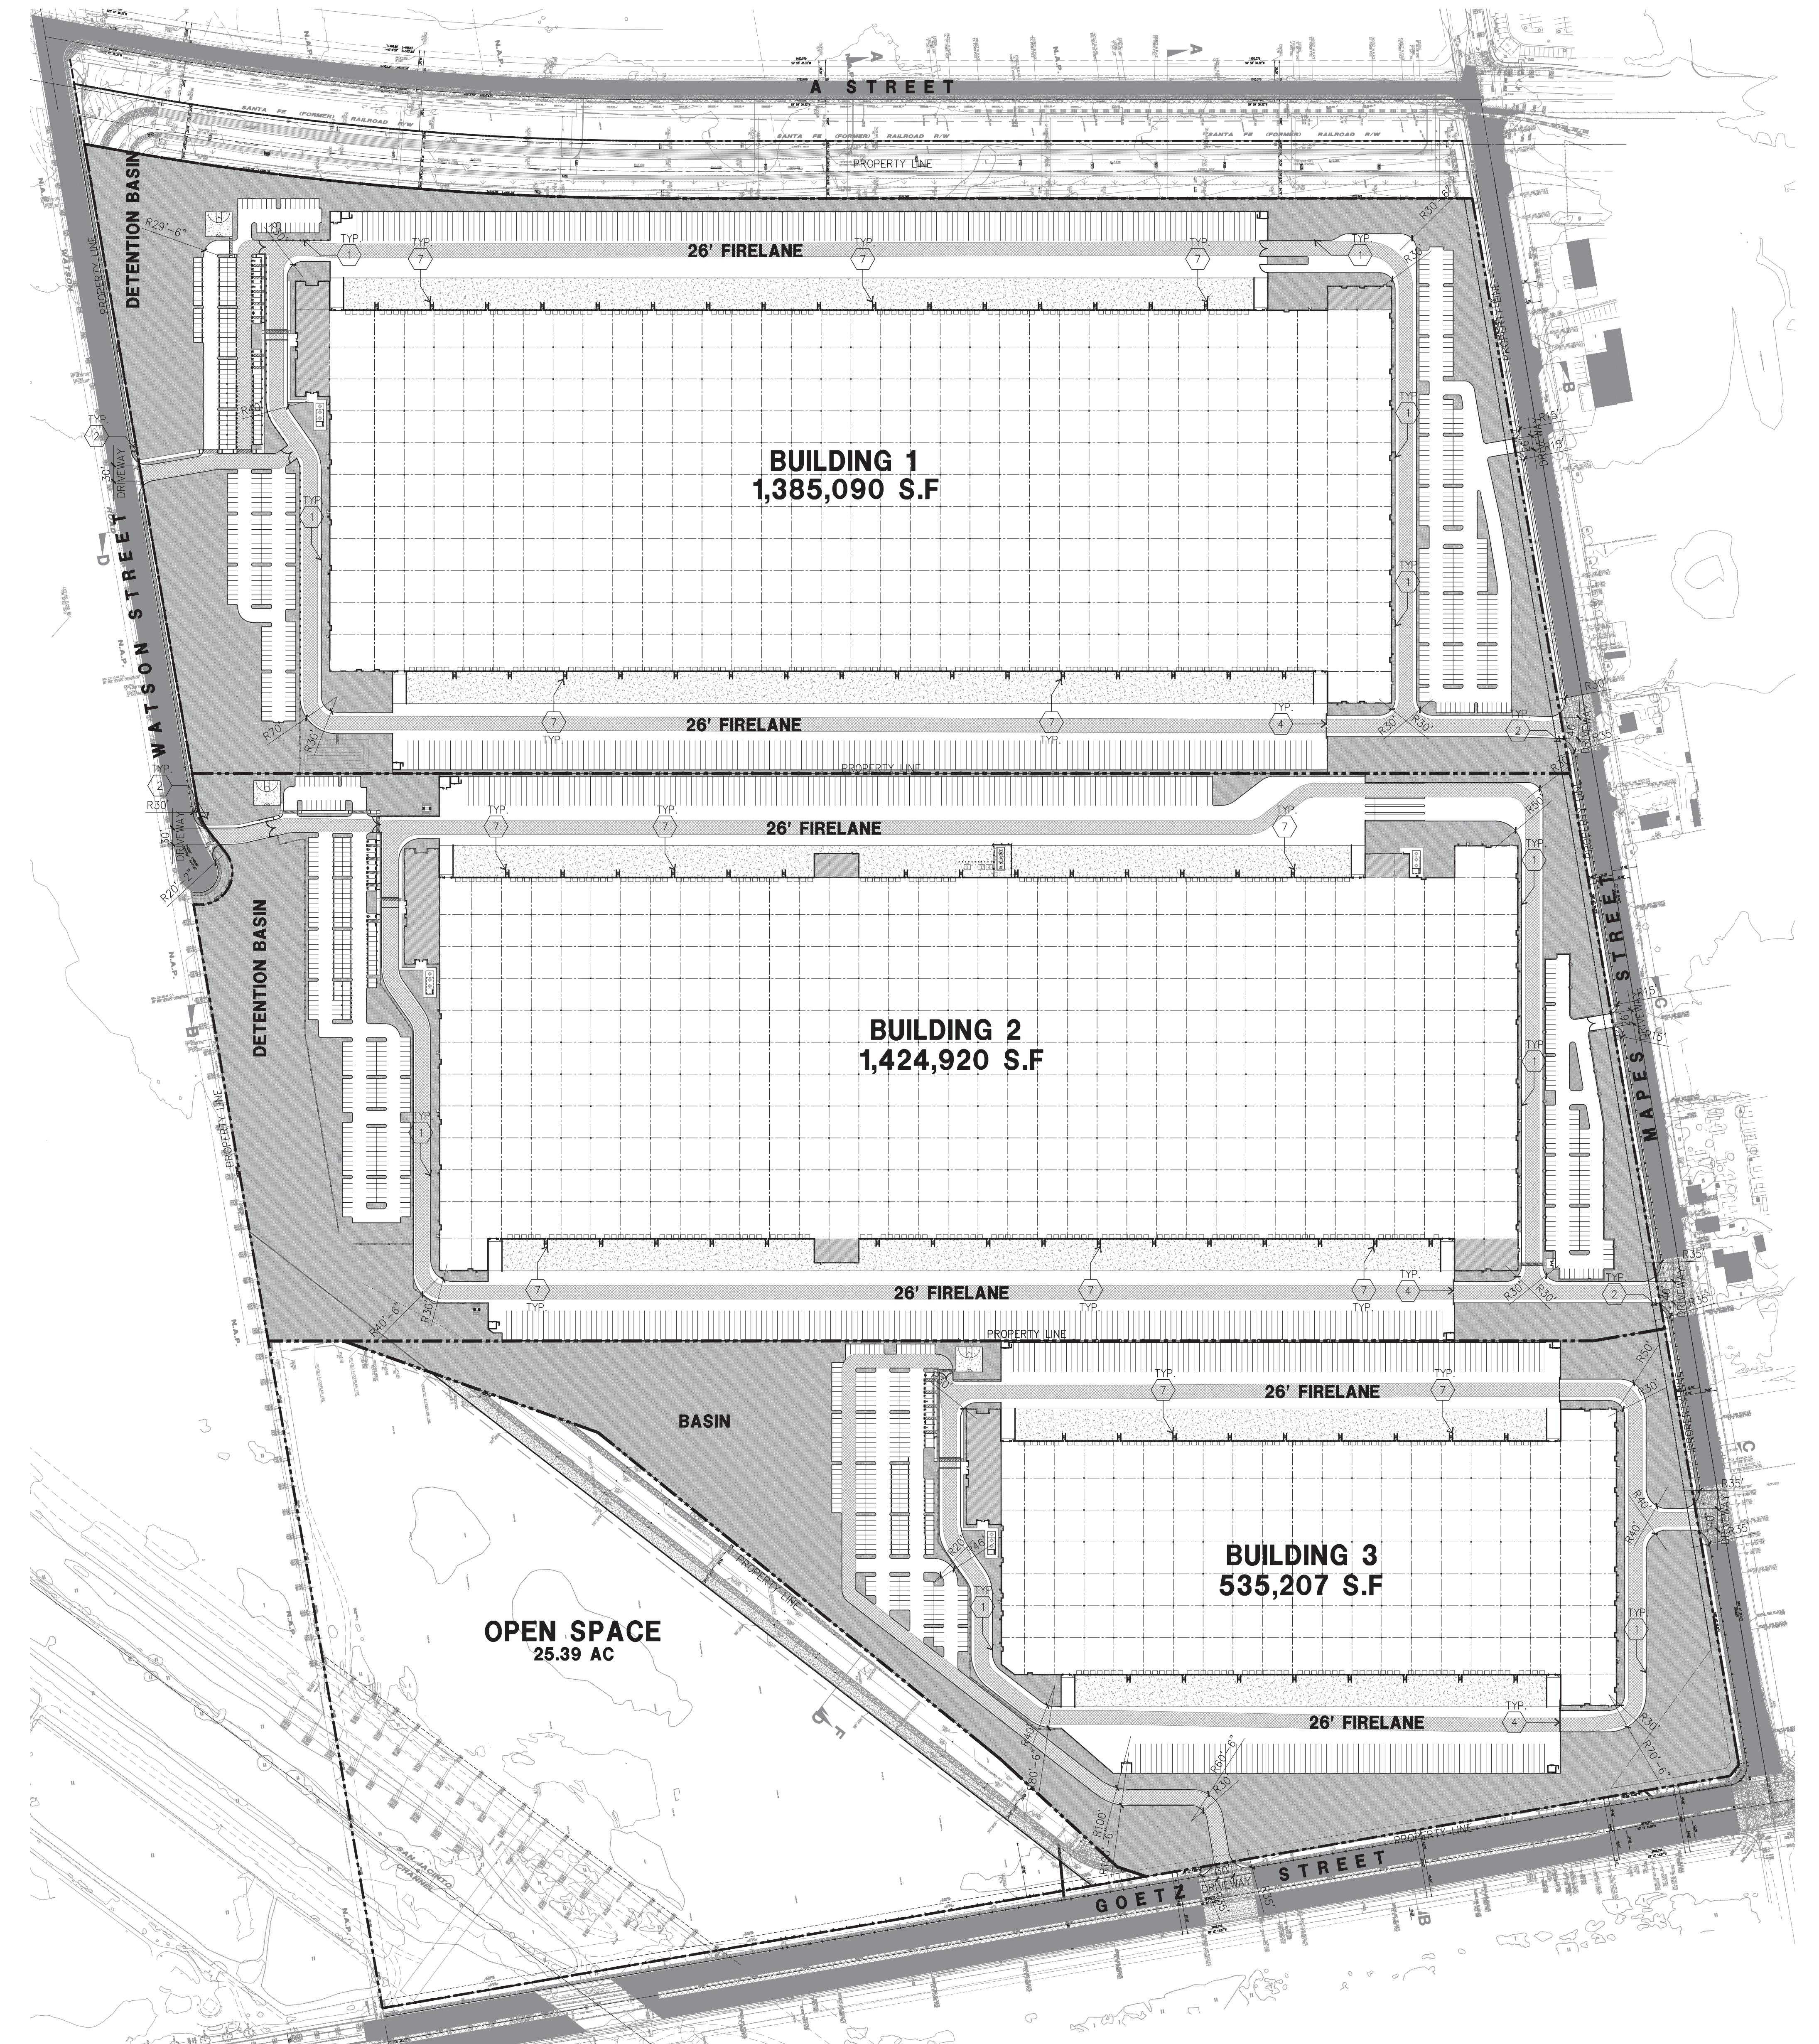



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The logo consists of a dark gray square above the text "Project: ERRIS LOGISTIC CENTER SOUTH".

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PERRIS, CA

Consultants:

THIENES

TURAL

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TECTION

GREGG


RLA

Title: OVERALL SITE PLAN

Project Number: 19214
Drawn by: CR
Date: 07/16/21


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GENERAL NOTES - SITE PLAN

- A. THE SOILS REPORT PREPARED BY SOCAL GEO PROJ. NO. _____ DATED ON _____ SHOULD BE A PART OF THESE CONTRACT DOCUMENTS.
 - B. IF SOILS ARE EXPANSIVE IN NATURE, USE STEEL REINFORCING FOR ALL SITE CONCRETE.
 - C. ALL DIMENSIONS ARE TO THE FACE OF CONCRETE WALL, FACE OF CONCRETE CURB OR GRID LINE U.N.O.
 - D. SEE "C" PLANS FOR ALL CONCRETE CURBS, GUTTERS AND SWALES. DETAILS ON SHEET AD.1 ARE MINIMUM STANDARDS.
 - E. THE ENTIRE PROJECT SHALL BE PERMANENTLY MAINTAINED WITH AN AUTOMATIC IRRIGATION SYSTEM, PRIOR TO INSTALLATION & AT LEAST 60 DAYS BEFORE BLDG. COMPLETION.
 - F. SEE "C" DRAWINGS FOR POINT OF CONNECTIONS TO OFF-SITE UTILITIES. CONTRACTOR SHALL VERIFY ACTUAL UTILITY CONTRACTOR SHALL VERIFY ACTUAL UTILITY LOCATIONS.
 - G. PROVIDE POSITIVE DRAINAGE AWAY FROM BLDG. SEE "C" DRAWINGS.
 - H. CONTRACTOR TO REFER TO "C" DRAWINGS FOR ALL HORIZONTAL CONTROL DIMENSIONS. SITE PLANS ARE FOR GUIDANCE AND STARTING LAYOUT POINTS.
 - I. SEE "C" DRAWINGS FOR FINISH GRADE ELEVATIONS.
 - J. CONCRETE SIDEWALKS TO BE A MINIMUM OF 4" THICK W/ TOOLED JOINTS AT 6' O.C. EXPANSION/CONSTRUCTION JOINTS SHALL BE A MAXIMUM 12' EA. WAY W/ 1:20 MAX. SLOPE. EXPANSION JOINTS TO HAVE COMPRESSIVE EXPANSION FILLER MATERIAL OF 1/4". SEE "L" DRAWINGS FOR FINISH.
 - K. PAINT CURBS AND PROVIDE SIGNS TO INFORM OF FIRE LANES AS REQUIRED BY FIRE DEPARTMENT.
 - L. CONSTRUCTION DOCUMENTS PERTAINING TO THE LANDSCAPE AND IRRIGATION OF THE ENTIRE PROJECT SITE SHALL BE SUBMITTED TO THE BUILDING DEPARTMENT AND APPROVED BY PUBLIC FACILITIES DEVELOPMENT PRIOR TO ISSUANCE OF BUILDING PERMITS.
 - M. PRIOR TO FINAL CITY INSPECTION, THE LANDSCAPE ARCHITECT SHALL SUBMIT A CERTIFICATE OF COMPLETION TO PUBLIC FACILITIES DEVELOPMENT.
 - N. ALL LANDSCAPE AND IRRIGATION DESIGNS SHALL MEET CURRENT CITY STANDARDS AS LISTED IN GUIDELINES OR AS OBTAINED FROM PUBLIC FACILITIES DEVELOPMENT.
 - O. LANDSCAPED AREAS SHALL BE DELINEATED WITH A MINIMUM SIX INCHES (6") HIGH CURB
 - P. APPROVED CONCEPTUAL LANDSCAPE PLAN PRIOR TO GRADING PERMIT

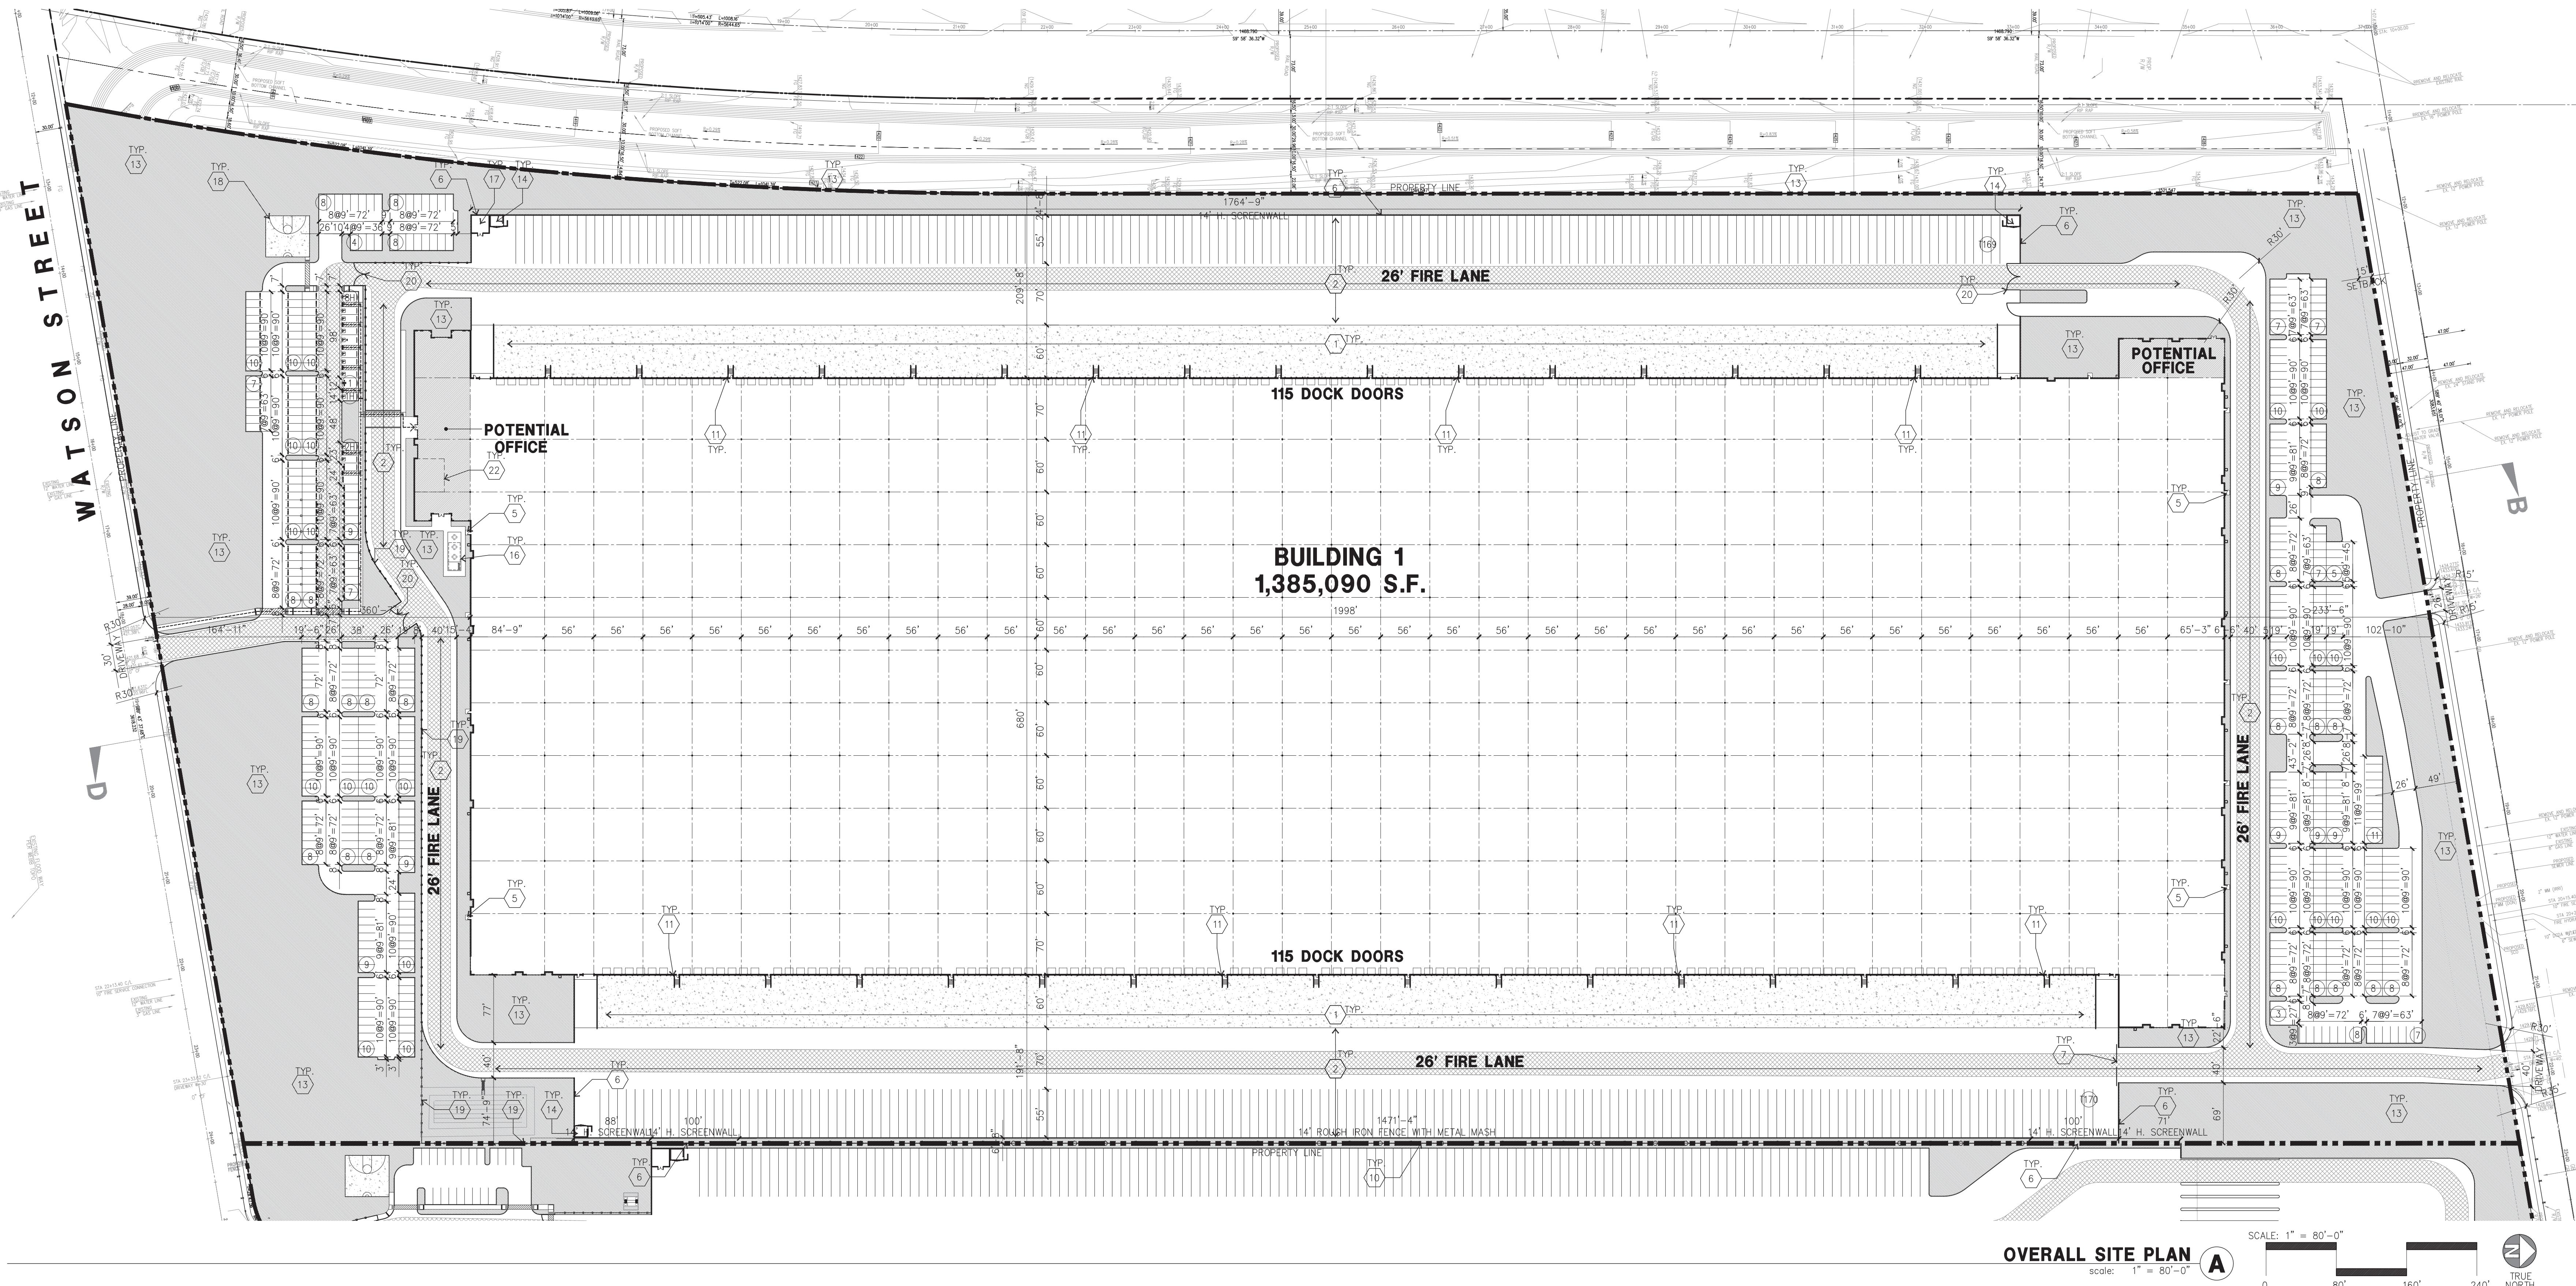

PROJECT DATA

	<u>BLDG. 1</u>	<u>BLDG. 2</u>	<u>BLDG. 3</u>	<u>SUB-TOTAL</u>	<u>OPEN SPACE</u>	<u>TOTAL</u>
SITE AREA						
In s.f.	2,838,979	2,792,109	1,618,408	7,247,550	1,106,032	8,353,588 s.f.
In acres	65.17	64.10	37.11	166.38	25.39	191.77 ac
BUILDING AREA						
Office	20,000	20,000	10,000	50,000		50,000 s.f.
Warehouse	1,365,090	1,404,920	525,207	3,295,217		3,295,217 s.f.
TOTAL	1,385,090	1,424,920	535,207	3,345,217		3,345,217 s.f.
CLEAR HEIGHT	42'	42'	40'			
COVERAGE	48.8%	51.0%	33.1%	46.2%		40.0%
AUTO PARKING REQUIRED						
Office: (office area is less than 10%)						
Whse: 1st 20K @ 1/1,000 s.f.	20	20	20	00		60 sta
2nd 20K @ 1/2,000 s.f.	10	10	10	30		30 sta
above 40K @ 1/5,000 s.f.	270	277	100	647		647 sta
TOTAL	300	307	130	737		737 sta
AUTO PARKING PROVIDED						
Standard (9' x 19')	443	307	207	957		957 sta
Standard Accessible Parking (9' x 19'	9	6	5	20		20 sta
Van Accessible Parking (12' x 19')	2	2	2	6		6 sta
EVCS (9' x 19')	27	20	14	61		61 sta
EV Capable (9' x 19')	80	60	41	181		181 sta
Standard EV ADA(9' x 19')	1	1	1	3		3 sta
VAN EV (12' x 19')	1	1	1	3		3 sta
Ambulatory (11'x19')	1	0	0	1		1 sta
TOTAL	564	397	271	1,232		1,232 sta
TRAILER PARKING REQUIRED						
Trailer: 1/5,000 SF	278	285	108	671		671 sta
TRAILER PARKING PROVIDED						
Trailer (10' x 55')	339	316	131	786		786 sta
ZONING ORDINANCE FOR CITY						

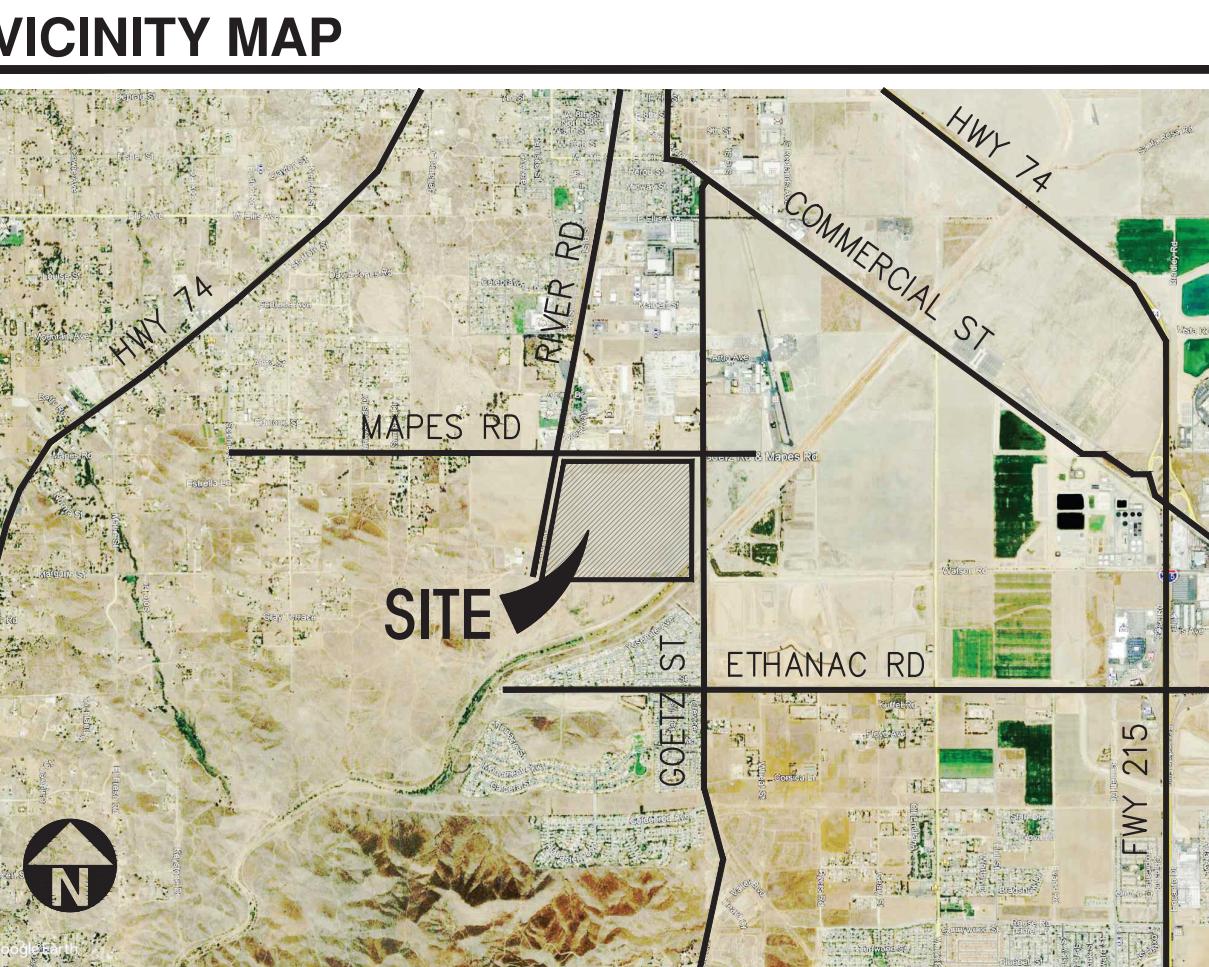SITE PLAN KEYNOTES

- | | |
|---|--|
| <p>① HEAVY BROOM FINISH CONC. PAVEMENT</p> <p>② ASPHALT PAVING PER CIVIL</p> <p>③ CONCRETE WALKWAY, MEDIUM BROOM FINISH.</p> <p>④ DRIVEWAY APRONS (DECORATIVE COLORED PAVING) TO BE CONSTRUCTED.</p> <p>⑤ 5'-6"X5'-6"X4" MIN. THICK CONCRETE EXTERIOR LANDING PAD TYP. AT ALL EXTERIOR MAN DOORS TO LANDSCAPE AREAS. FINISH TO BE MEDIUM BROOM FINISH. SLOPE TO BE 1/4" : 12" MAX. PROVIDE WALK TO PUBLIC WAY OR DRIVE WAY W/ 1:20 MAX. AS REQ. BY CITY INSPECTOR.</p> <p>⑥ 14'H CONCRETE TILT-UP SCREEN WALL</p> <p>⑦ PROVIDE 8'H TUBE STEEL, MANUALLY OPERATED GATES WITH KNOX-PAD LOCK PER FIRE DEPARTMENT STANDARDS PER DRIVEWAY. GATE TO BE DESIGNED FOR 90 MPH WIND LOAD, EXPOSURE "C". CONTRACTOR TO DESIGN & DETAIL GATES.</p> <p>⑧ FUTURE GUARD HOUSE</p> <p>⑨ TRANSFORMER.</p> <p>⑩ 14'H WROUGHT IRON FENCE WITH METAL MESH</p> | <p>⑪ EXTERIOR DOWNSPOUTS</p> <p>⑫ EXTERIOR PARKING LIGHT POLE.</p> <p>⑬ LANDSCAPE. SEE "L" DWGS. LANDSCAPE AREAS INDICATED BY SHADED PATTERN</p> <p>⑭ COVERED TRASH ENCLOSURE E/DAB-A4.1</p> <p>⑮ BICYCLE RACKS</p> <p>⑯ OUTDOOR PATIO, EMPLOYEE BREAK AREA. OUTDOOR BREAK AREA NEXT TO POTENTIAL OFFICE TO BE SHADED. SEE TRELLIS DETAIL G/DAB-A4.1</p> <p>⑰ PUMP HOUSE, G/DAB-A4.1</p> <p>⑱ OUTDOOR RECREATION AREA – HALF BASKETBALL COURT</p> <p>⑲ 8'H WROUGHT IRON FENCE</p> <p>⑳ WROUGHT IRON SWING GATE FOR FIRE DEPARTMENT ACCESS ONLY. PROVIDE KNOX BOX.</p> <p>㉑ SMOKING AREA.</p> <p>㉒ CAFETERIA</p> <p>㉓ WALKING TRAIL</p> <p>㉔ CROSSWALK</p> <p>㉕ EXERCISE ROOM</p> |
|---|--|

SITE LEGEND

	LANDSCAPED AREA		LIGHT STANDARD
	PAVING – SEE "C" DWGS. FOR THICKNESS		EXISTING PUBLIC FIRE HYDRANT
	CONCRETE PAVING SEE "C" DRWGS. FOR THICKNESS		PRIVATE FIRE HYDRANT APPROXIMATE LOCATION F.H.
	PROPERTY LINE		FIRE LANE 26'
	STANDARD PARKING STALL (9' X 19')	C.B. 	CATCH BASIN, APPROX. LOCATION. SEE CIVIL DRWGS.
	HANDICAP PARKING STALL (9' X 19')		TRAIL/MAINTENANCE ROAD
	PATH OF TRAVEL		
	8'H WROUGHT IRON FENCE		

E	11/3/13
SETBACKS	16.8%
<u>Building</u>	
Mapes St. - 10' (Local)	
Goetz St. - 15' (Arterial)	
A Street - 10' (Local)	
Side/ Rear - none, adjoining R zone- 20'	

OFFICIAL USE ONLY



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PERRIS, CA

L	THIENES
CTURAL	-
ANICAL	-
MBING	-
TRICAL	GREGG
SCAPE	RLA
OTECTION	-
NGINEER	-


OVERALL FLOOR PLAN

ect Number: 19214
own by: CR

07/16/21


ANSWER: _____

For further information, please contact:

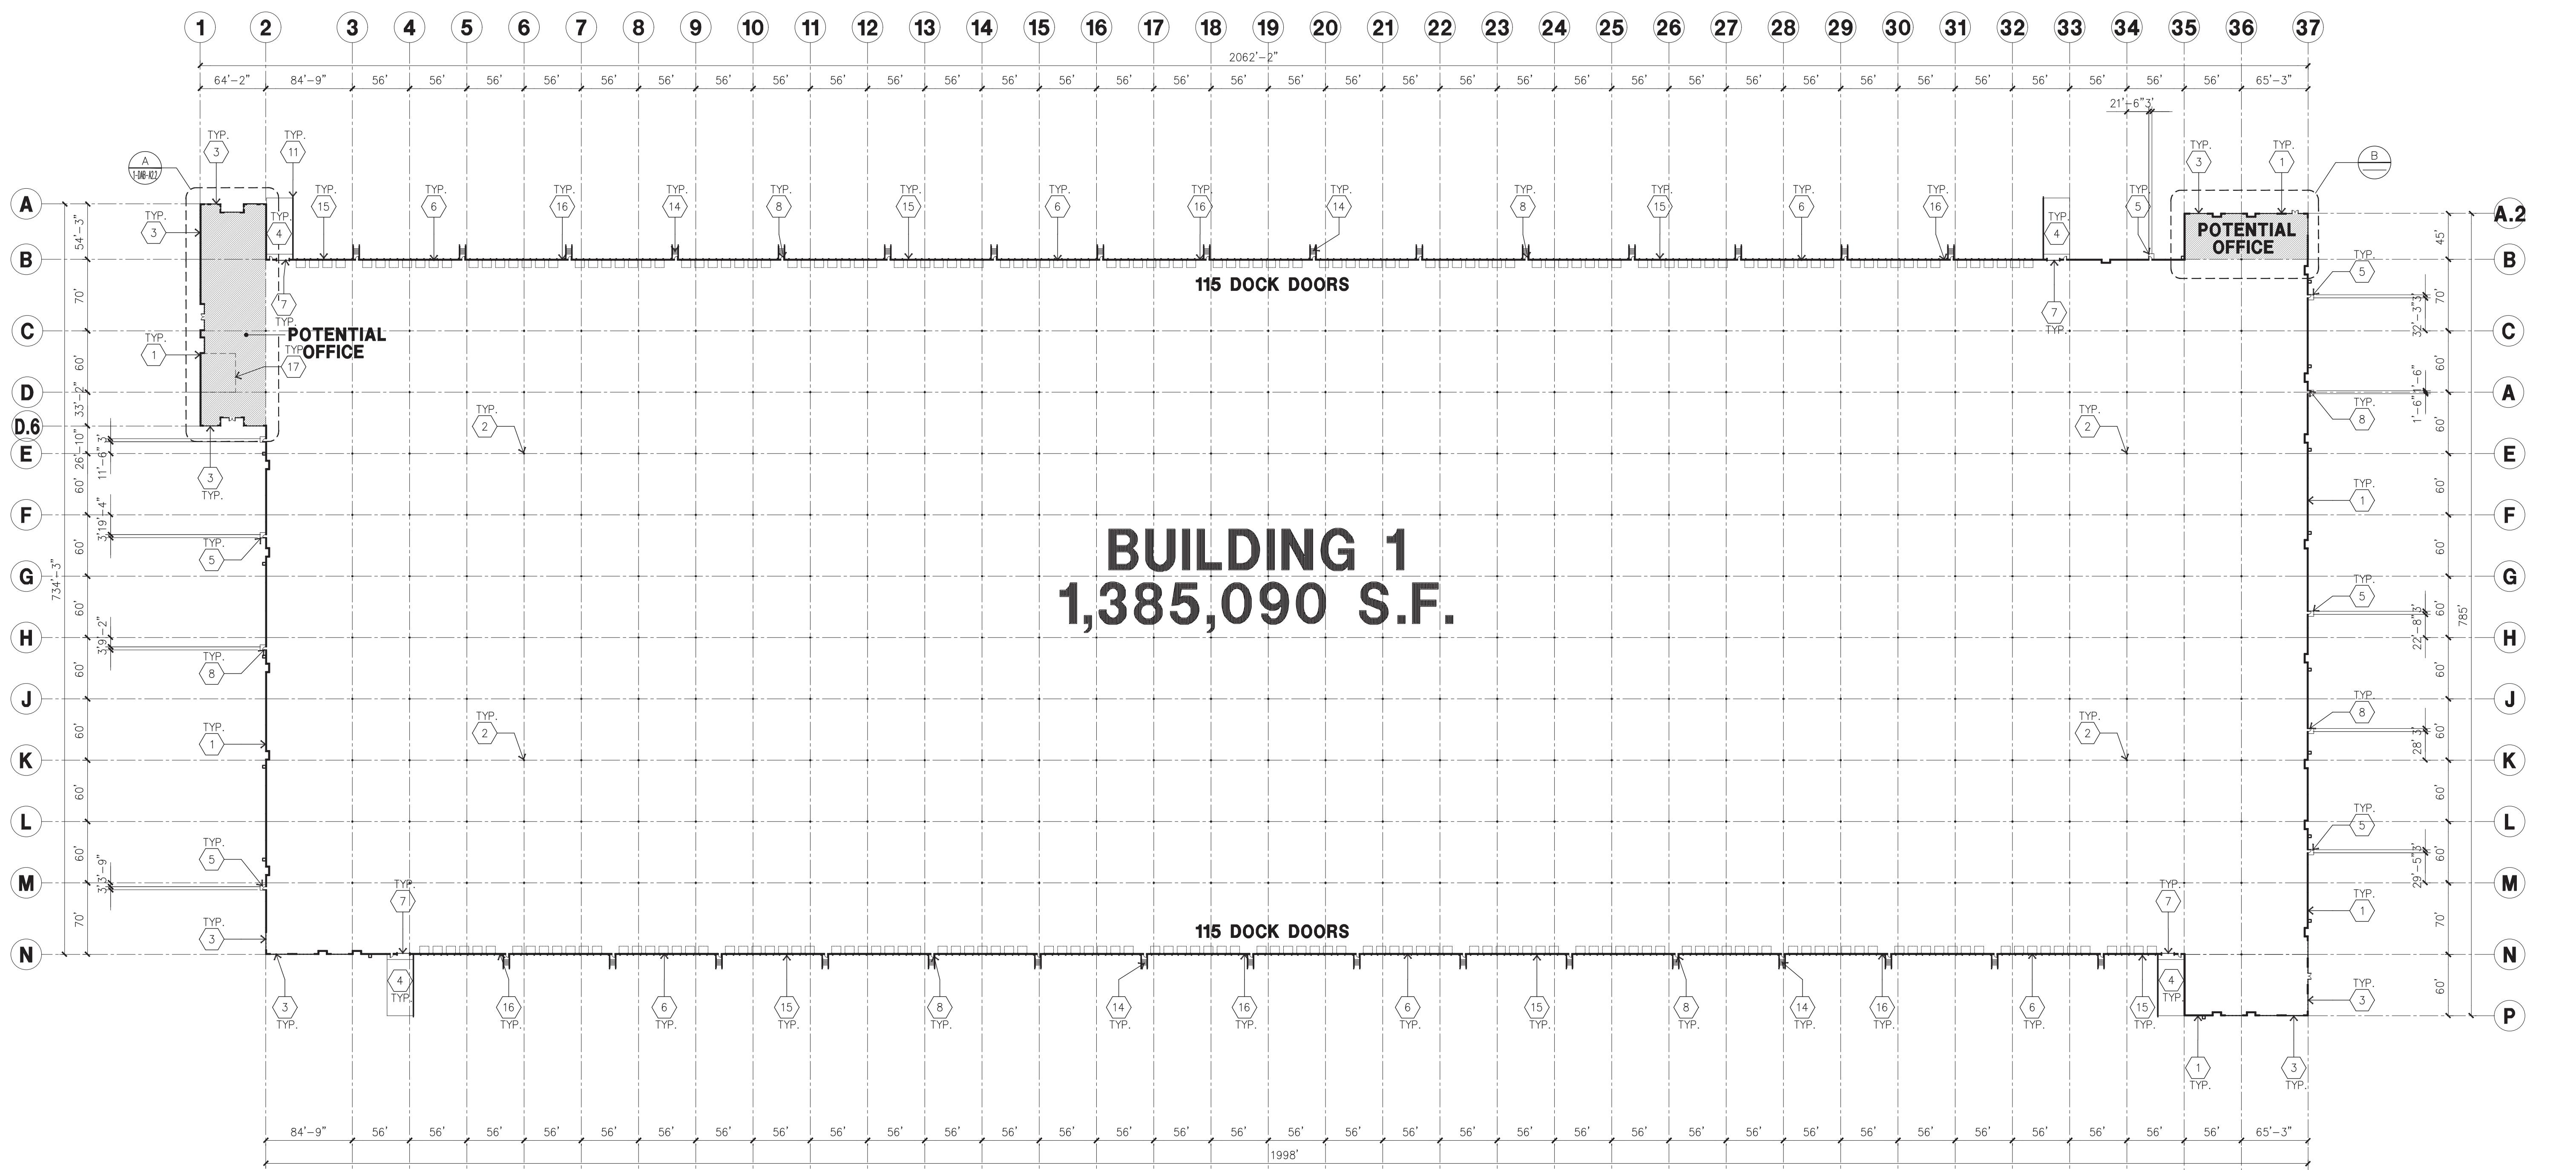

OVERALL FLOOR PLAN


FLOOR PLAN

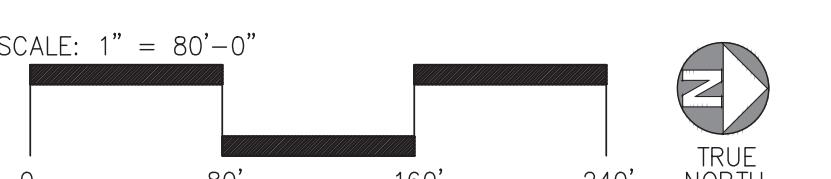

KEYNOTES - FLOOR PLAN

- 1 CONCRETE TILT-UP PANEL.
 - 2 STRUCTURAL STEEL COLUMN.
 - 3 TYPICAL STOREFRONT SYSTEM WITH GLAZING. SEE OFFICE BLOW-UP AND ELEVATIONS FOR SIZE, COLOR AND LOCATIONS.
 - 4 CONCRETE RAMP
 - 5 5'-6"X5'X4" THICK CONCRETE EXTERIOR LANDING PAD TYPICAL AT ALL EXTERIOR MAN DOORS TO LANDSCAPED AREA. FINISH TO BE MEDIUM BROOM FINISH. PROVIDE WALK TO HARD SURFACE PER CITY REQUIREMENTS.
 - 6 9'X10' TRUCK DOOR, VERTICAL LIFT, STANDARD GRADE.
 - 7 12'X14' DRIVE THRU, VERTICAL LIFT, STANDARD GRADE.
 - 8 3'X7' HOLLOW METAL EXTERIOR MAN DOOR.
 - 9 SOFFIT ABOVE
 - 0 ROOF ACCESS LADDER
 - 1 CONC. FILLED GUARD POST. 6" DIA. UNO 42"H.
 - 2 INTERIOR ROOFDRAIN WITH OVERFLOW SCUPPER
 - 3 EMPLOYEE AMENITIES: BREAK ROOM & COFFEE BAR W/INTERNET ACCESS
 - 4 EXTERIOR CONCRETE STAIR
 - 5 DOCK BUMPER
 - 6 METAL LOUVER
 - 7 CAFETERIA
 - 8 EXERCISE ROOM

GENERAL NOTES - FLOOR PLAN

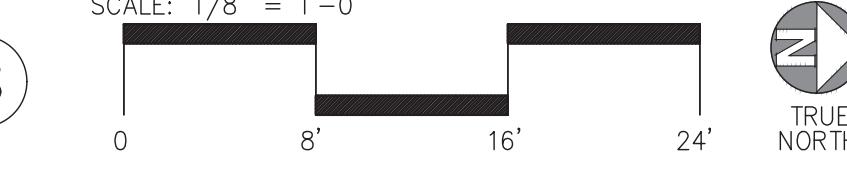



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LANDSCAPE
FIRE PROTECTION
SOILS ENGINEER

GREGG RLA

Title: ENLARGED FLOOR PLAN

Project Number: 19214


Drawn by: CR

Date: 07/16/21

Revision: _____

Sheet:

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ENLARGED FLOOR PLAN A

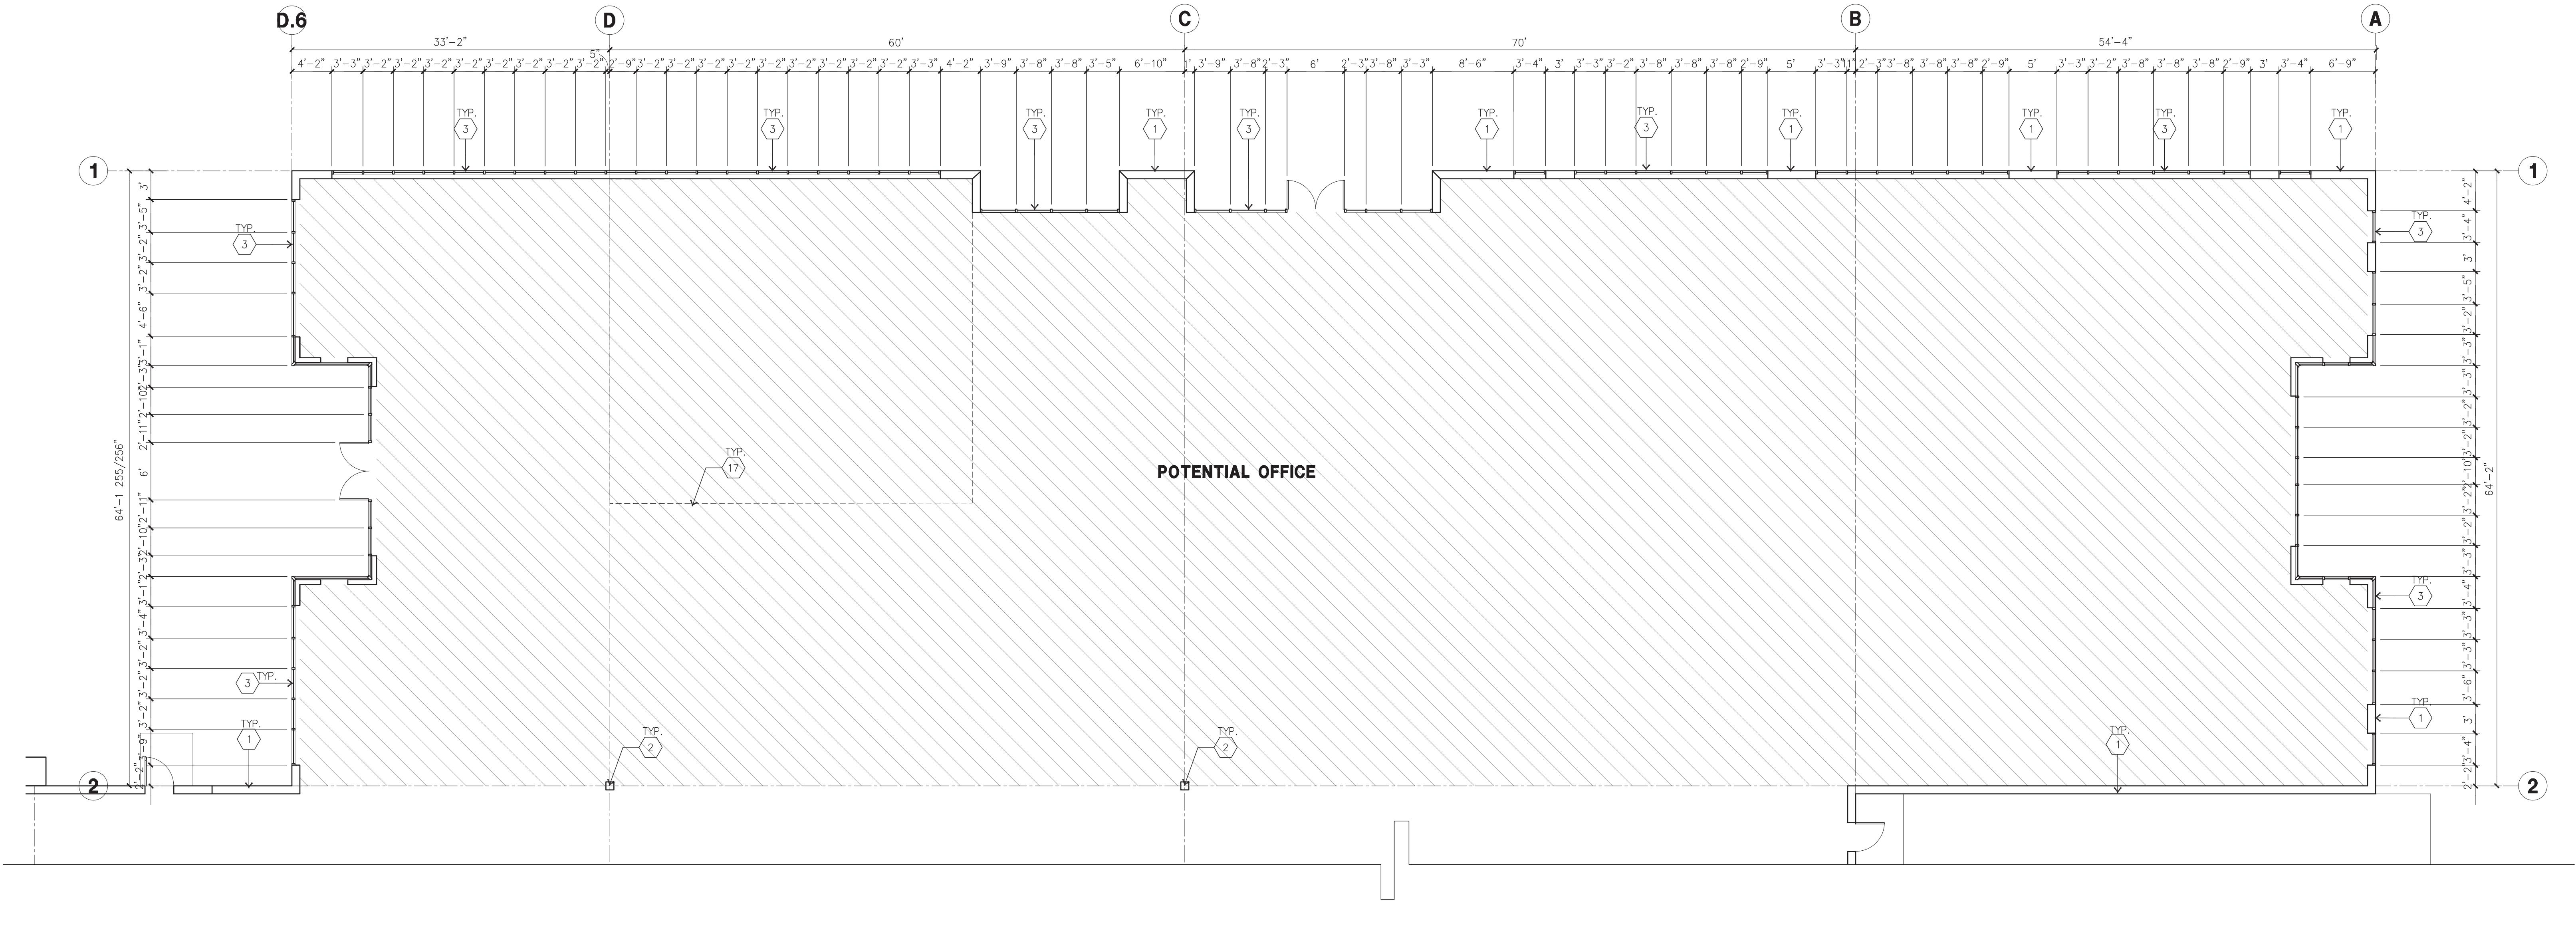scale: 1/8"=1'-0"



KEYNOTES - FLOOR PLAN

- ① CONCRETE TILT-UP PANEL.
- ② STRUCTURAL STEEL COLUMN.
- ③ TYPICAL STOREFRONT SYSTEM WITH GLAZING. SEE OFFICE BLOW-UP AND ELEVATIONS FOR SIZE, COLOR AND LOCATIONS.
- ④ CONCRETE RAMP.
- ⑤ 5'-6"x5'x4" THICK CONCRETE EXTERIOR LANDING PAD TYPICAL AT ALL EXTERIOR MAN DOORS TO LANDSCAPED AREA. FINISH TO BE MEDIUM BROOM FINISH. PROVIDE WALK TO HARD SURFACE PER CITY REQUIREMENTS.
- ⑥ 9'x10' TRUCK DOOR, VERTICAL LIFT, STANDARD GRADE.
- ⑦ 12'x14' DRIVE THRU, VERTICAL LIFT, STANDARD GRADE.
- ⑧ 3'x7' HOLLOW METAL EXTERIOR MAN DOOR.
- ⑨ SOFFIT ABOVE.
- ⑩ ROOF ACCESS LADDER.
- ⑪ CONC. FILLED GUARD POST. 6" DIA. UNO 42".
- ⑫ INTERIOR ROOFDRAIN WITH OVERFLOW SCUPPER.
- ⑬ EMPLOYEE AMENITIES: BREAK ROOM & COFFEE BAR W/INTERNET ACCESS.
- ⑭ EXTERIOR CONCRETE STAIR.
- ⑮ DOCK BUMPER.
- ⑯ METAL LOUVER.
- ⑰ CAFETERIA.
- ⑱ EXERCISE ROOM.

GENERAL NOTES - FLOOR PLAN


- A. THIS BUILDING IS DESIGNED FOR HIGH PILE STORAGE WITH FIRE ACCESS MAN DOORS AT 100' MAXIMUM O.C. A SEPERATE PERMIT WILL BE REQUIRED FOR ANY RACKING/CONVEYER SYSTEMS.
- B. FIRE HOSE LOCATIONS SHALL BE APPROVED PER FIRE DEPARTMENT.
- C. THE BUILDING FLOOR SLAB SLOPES 1/2%, SEE "C" DRAWINGS FOR FINISH SURFACE ELEVATIONS.
- D. FLOOR SLAB SHALL BE SEALED WITH LAPOLIDITH (MANUFACTURER: SONOBORN) OR APPROVED EQUAL.
- E. WAREHOUSE INTERIOR CONCRETE WALLS ARE PAINTED WHITE. COLUMNS ARE TO RECEIVE GREY PRIMER ONLY. ALL GYP. BD. WALLS IN WAREHOUSE TO RECEIVE 1 COAT OF WHITE TO COVER.
- F. SLOPE POUR STRIP 1/2" TO EXTERIOR AT ALL PERSONAL EXITS. SEE "S" DRAWINGS FOR POUR STRIP LOCATION.
- G. ALL DIMENSIONS ARE TO THE FACE OF CONCRETE PANEL WALL, GRIDLINE, OR FACE OF STUD U.N.O.
- H. SEE CIVIL DRAWINGS FOR POINT OF CONNECTIONS TO OFF-SITE UTILITIES. CONTRACTOR TO VERIFY ACTUAL UTILITY LOCATIONS.
- I. FOR DOOR TYPES AND SIZES, SEE DETAIL SHEET AD.4. NOTE: ALL DOORS PER DOOR SCHEDULE ARE FINISH OPENINGS.
- J. CONTRACTOR TO PROTECT AND KEEP THE FLOOR SLAB CLEAN. ALL EQUIPMENT TO BE DIAPERED INCLUDING CARS AND TRUCKS.

1-DAB-A2.2




NORTH ELEVATION **A**

scale: 1" = 30'-0"

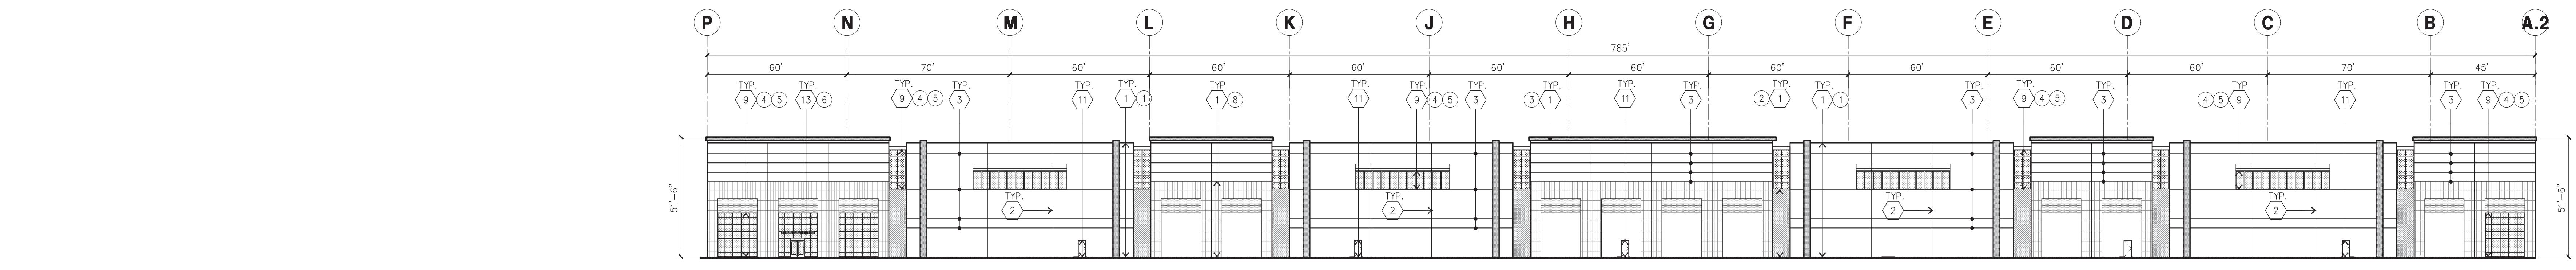

IDI Logistics **B**

scale: 1" = 30'-0"

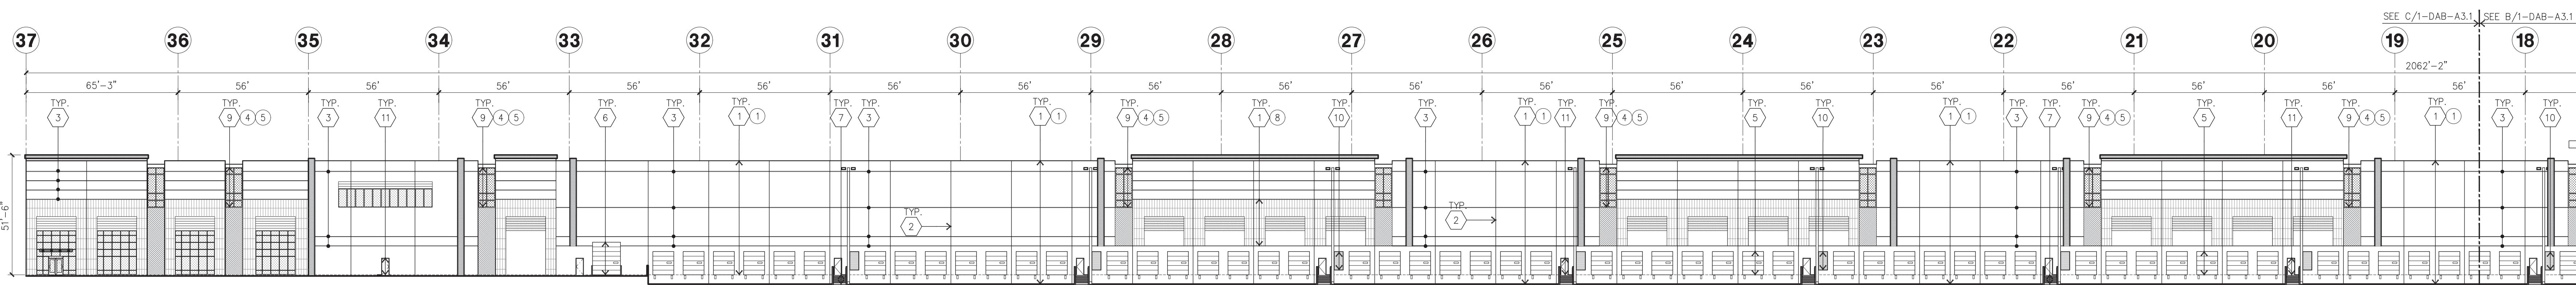

WEST ELEVATION **B**

scale: 1" = 30'-0"


Project: **PERRIS LOGISTIC CENTER**

SOUTH

MAPES ST. & A ST.
PERRIS, CA


WEST ELEVATION CONT' **C**

scale: 1" = 30'-0"

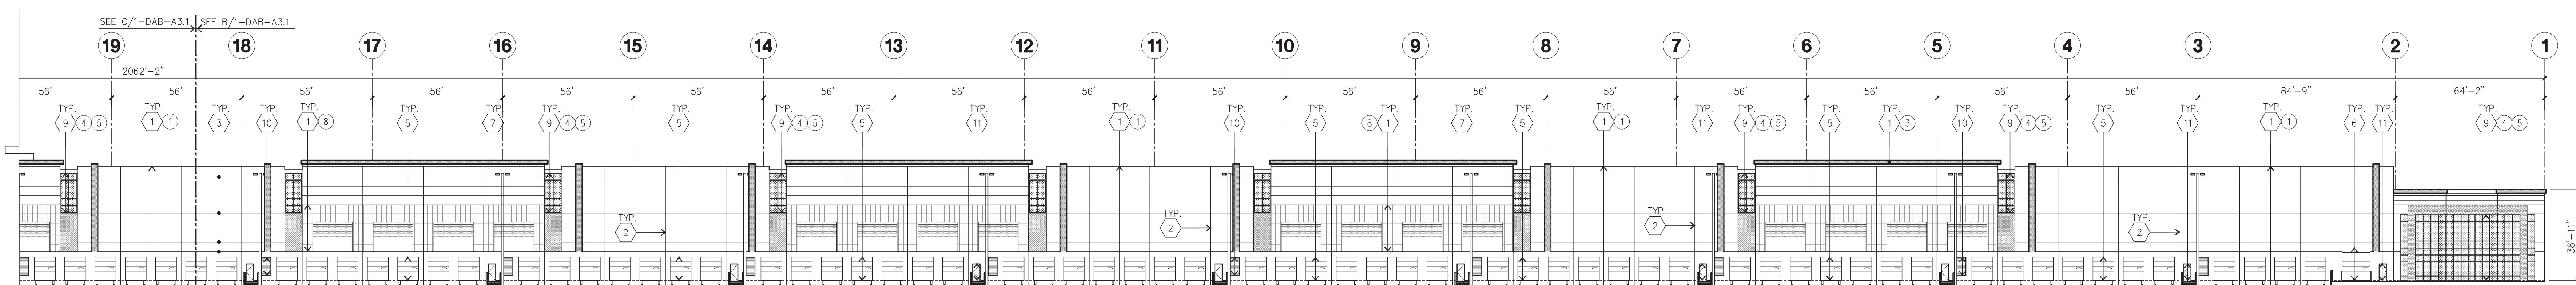

SOUTH ELEVATION **D**

scale: 1" = 30'-0"

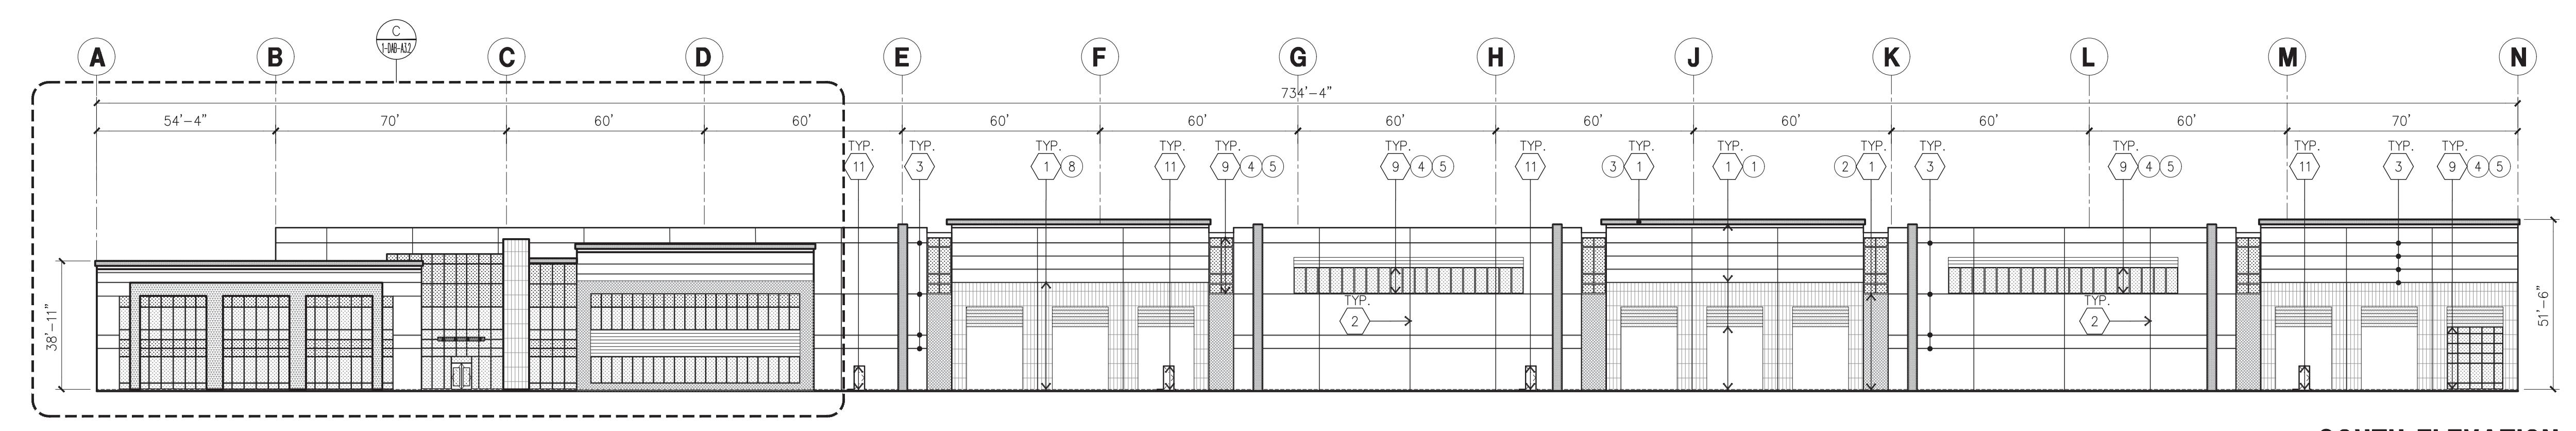

KEYNOTES - ELEVATIONS

- 1 CONCRETE TILT-UP PANEL (PAINTED).
- 2 PANEL JOINT.
- 3 PANEL REVEAL.
- 4 CONCRETE TILT-UP SCREEN WALL.
- 5 OVERHEAD DOOR @ DOCK HIGH.
- 6 OVERHEAD DOOR @ DRIVE THRU.
- 7 CONCRETE STAIR, LANDING AND CONC. GUARDRAIL.
- 8 DOCK BUMPER.
- 9 ALUMINUM STOREFRONT FRAMING w/ TEMPERED GLAZING AT ALL DOORS SIDELITES ADJACENT TO DOORS AND GLAZING w/ BOTTOMS LESS THAN 18" ABOVE F.F. ELEVATION.
- 10 LOUVER (SIZE AND LOCATION APPROX. ONLY).
- 11 HOLLOW METAL DOORS.
- 12 INTERIOR ROOF DRAIN WITH OVERFLOW SCUPPER.
- 13 EXTERIOR CANOPY.

GENERAL NOTES - ELEVATIONS

- A. ALL PAINT COLOR CHANGES TO OCCUR AT INSIDE CORNERS UNLESS NOTED OTHERWISE.
- B. ALL PAINT FINISHES ARE TO BE FLAT UNLESS NOTED OTHERWISE.
- C. T.O.P. = TOP OF PARAPET - ELEVATION.
- D. F.F. = FINISH FLOOR ELEVATION.
- E. STOREFRONT CONSTRUCTION: GLASS, METAL ATTACHMENTS AND LINTELS SHALL BE DESIGNED TO RESIST 90 MPH. EXPOSURE "C" WINDS. CONTRACTOR SHALL SUBMIT SHOP DRAWINGS PRIOR TO INSTALLATION.
- F. CONTRACTOR SHALL FULLY PAINT ONE CONCRETE PANEL w/ SELECTED COLORS. ARCHITECT AND OWNER SHALL APPROVE PRIOR TO PAINTING REMAINDER OF BUILDING.

COLOR SCHEDULE - ELEVATIONS

- | | |
|---|---|
| ① | PAINT, COLOR : SW 7005 PURE WHITE |
| ② | PAINT, COLOR : SW 7071 GRAY SCREEN |
| ③ | PAINT, COLOR : SW 7072 ONLINE |
| ④ | MULLIONS COLOR : CLEAR ANODIZED |
| ⑤ | GLAZING COLOR : BLUE REFLECTIVE |
| ⑥ | METAL CANOPY : STEEL CANOPY P1 WITH CLEAR RESIN TOP |
| ⑦ | PAINT, COLOR : ANATOLIA ERAMOSA COLOR: CARBON |
| ⑧ | PAINT, COLOR : ANATOLIA ERAMOSA COLOR: ICE |

GLAZING LEGEND

- NOTE: ALL EXTERIOR AND INTERIOR GLAZING SHALL BE TEMPERED.
- | | | | |
|---|-----------------------|---|-------------------------|
| ④ | TEMPERED VISION GLASS | ⑤ | TEMPERED SPANDREL GLASS |
|---|-----------------------|---|-------------------------|
- ALL GLASS TO BE NON-REFLECTIVE
- V : VISION GLASS
1/4" VISTACOOL PACIFICA
- S : SPANDREL WITH CONCRETE BEHIND
1/4" VISTACOOL PACIFICA WITH WARM GRAY OPACICOAT PAINTED ON
REFLECTIVE. INSTALLED ON CONCRETE.
- MULLIONS : ANODIZED CLEAR

Project Number: 19214


Drawn by: CR

Date: 07/16/21

Revision:

Sheet:

1-DAB-A3.1

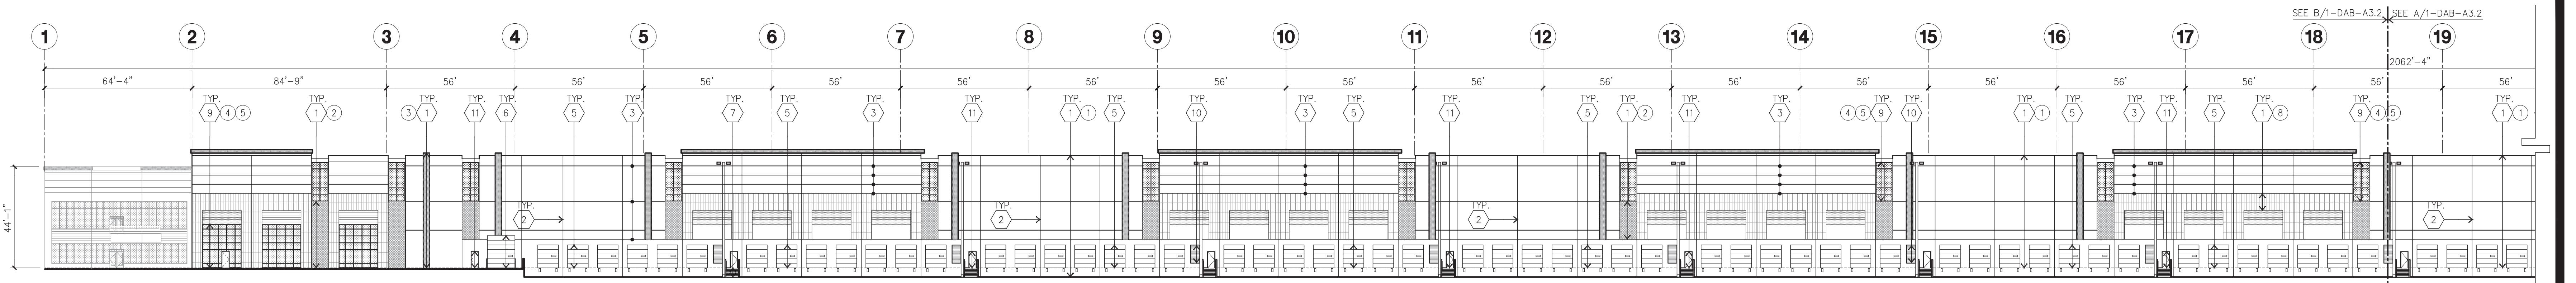


HPA
chitecture

hpa, inc.
8831 bardeen avenue - ste. #100
irvine, ca
92612
tel: 949•863•1770
fax: 949•863•0851
email: hpa@hparchs.com



LAST ELEVATION

scale: 1" = 30'-0" 

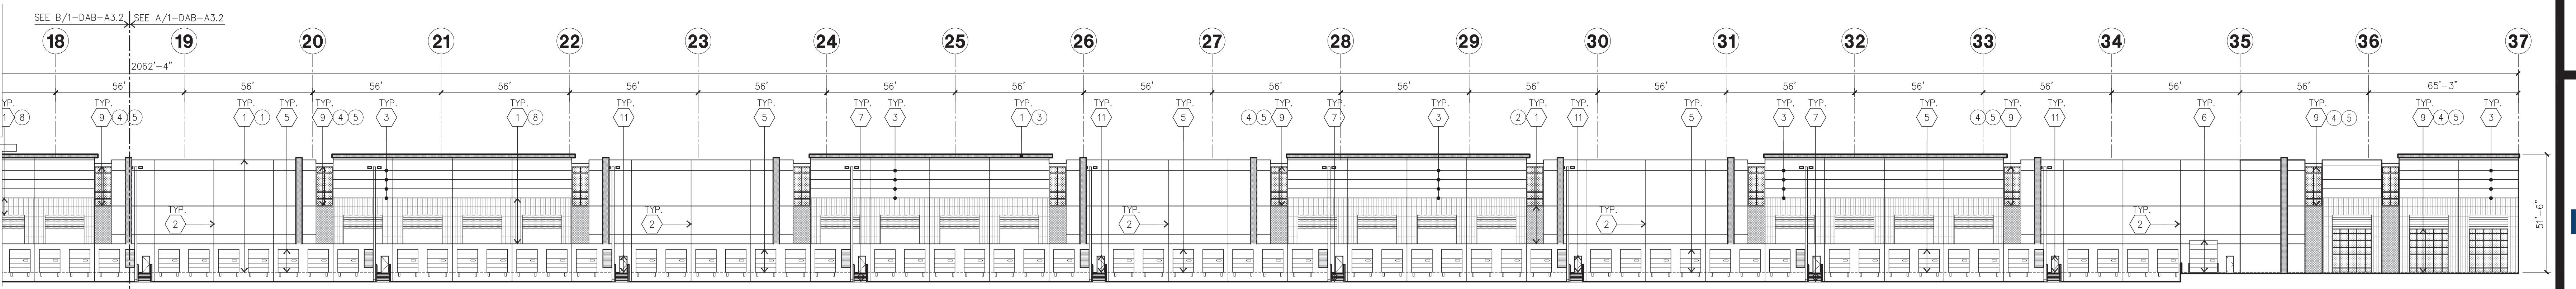


IDI Logistics

IDI Logistics

840 Apollo street, Suite 343
El Segundo, CA 90245
tel: 213.330.8030

EAST ELEVATION CONT'

scale: 1" = 30'-0"

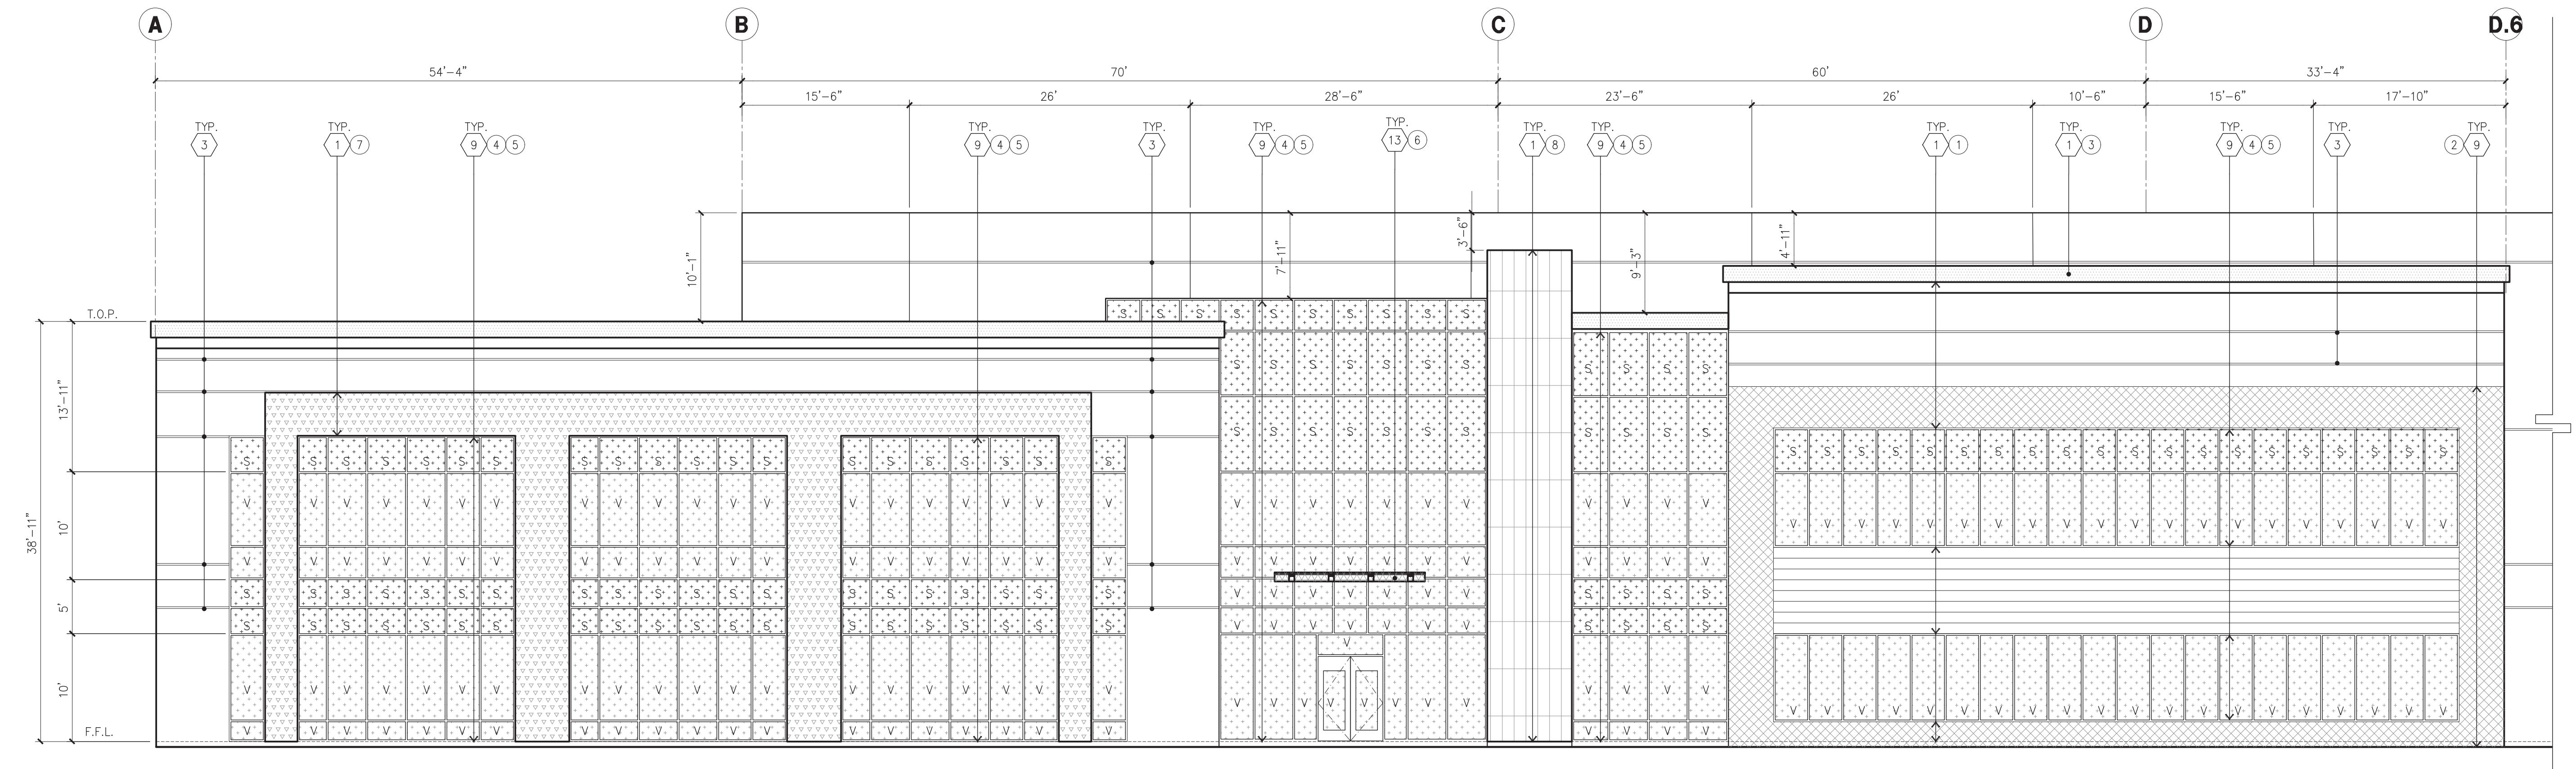

Project: ERRIS LOGISTIC CENTER SOUTH

MAPES ST. & A ST.
PERRIS, CA

	Consultants:
VIL	THIENES
STRUCTURAL	-
MCHANICAL	-
UMBING	-
CTRICAL	GREGG
DSCAPE	RLA
PROTECTION	-
S ENGINEER	-

ENLARGED SOUTH ELEVATION

$1/8'' = 1'-0''$

KEYNOTES - ELEVATIONS

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2 PANEL JOINT.

3 PANEL REVEAL

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5 OVERHEAD DOOR @ DOCK HIGH.

6 OVERHEAD DOOR @ DRIVE THRU.

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SIDELITES ADJACENT TO DOORS AND GLAZING W/ BOTTOMS LESS THAN 18"
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WORK SCHEDULE - ELEVATIONS

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 PAINT. COLOR : SW 7071 GRAY SCREEN

 PAINT. COLOR : SW 7072 ONLINE

 MULLIONS COLOR : CLEAR ANODIZED

 GLAZING COLOR : BLUE REFLECTIVE

 METAL CANOPY : STEEL CANOPY P1 WITH CLEAR RESIN TOP

 PAINT. COLOR : ANATOLIA ERAMOSA COLOR: CARBON

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MAZING LEGEND

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TEMPERED VISION GLASS  TEMPERED SPANDREL GLASS

GLASS TO BE NON-REFLECTIVE
VISION GLASS
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SPANDREL WITH CONCRETE BEHIND
1/4" VISTACOOL PACIFICA WITH WARM GRAY OPACICOAT PAINTED ON
REFLECTIVE. INSTALLED ON CONCRETE.

OPTIONS : ANODIZED CLEAR

Project Number: 19214
Drawn by: CR
Date: 07/16/21

-DAB-A3.2