


OVERALL SITE PLAN
 scale: 1" = 80'-0"
 0 80' 160' 240' TRUE NORTH

PROJECT DATA

	BLDG. 1	BLDG. 2	BLDG. 3	SUB-TOTAL	OPEN SPACE	TOTAL
SITE AREA						
In s.f.	2,782,109	2,782,109	4,154,699	2,477,558	1,106,632	8,353,588 s.f.
In acres	64.10	64.10	93.11	61.38	25.39	191.77 ac.
BUILDING AREA						
Office	20,000	20,000	10,000	50,000		50,000 s.f.
Warehouse	1,265,000	1,458,000	985,000	3,708,000		3,708,000 s.f.
TOTAL	1,285,000	1,478,000	995,000	3,758,000		3,758,000 s.f.
CLEAR HEIGHT	42'	42'	42'	42.2%		40.0%
COVERAGE	48.8%	51.0%	35.1%	48.2%		40.0%
AUTO PARKING REQUIRED						
Office (office area is less than 10%)	20	20	20	60		60 stalls
Warehouse (1st 20K @ 10,000 s.f.)	20	10	10	30		30 stalls
Warehouse (2nd 20K @ 10,000 s.f.)	20	10	10	30		30 stalls
Warehouse (above 45K @ 15,000 s.f.)	200	277	69	647		647 stalls
TOTAL	300	307	50	737		737 stalls
AUTO PARKING PROVIDED						
Standard (9' x 19')	653	307	199	957		957 stalls
Standard Accessible Parking (9' x 19')	6	6	6	24		24 stalls
Van Accessible Parking (12' x 19')	2	2	2	6		6 stalls
EV/DS (9' x 19')	30	30	30	181		181 stalls
EV/DS (9' x 19')	30	30	30	181		181 stalls
Standard EV ADA (9' x 19')	1	1	1	3		3 stalls
VAN EV (12' x 19')	1	1	1	3		3 stalls
Antibody (12' x 19')	1	0	0	1		1 stall
TOTAL	724	397	171	1,232		1,232 stalls
TRAILER PARKING REQUIRED						
Trailer (10' x 50')	324	285	139	671		671 stalls
TRAILER PARKING PROVIDED						
Trailer (10' x 50')	324	285	139	671		671 stalls
ZONING ORDINANCE FOR CITY						
Zoning Designation - General Industrial						
MAXIMUM BUILDING HEIGHT ALLOWED						
Height - 50'						
MAXIMUM FLOOR AREA RATIO						
FAA - 10						
Percentage - 12%						
LANDSCAPE REQUIREMENT						
LANDSCAPE PROVIDED	476713	495173	494309			
	18.8%	16.1%	30.6%			
SETBACKS						
Building						
Mapes St. - 10' (Local)						
Genet St. - 15' (Arterial)						
A Street - 15' (Local)						
Side/Rear - none, adjoining R zone - 20'						

VICINITY MAP

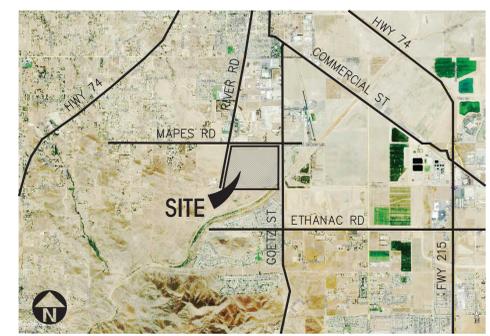

GENERAL NOTES - SITE PLAN

- A. THE SOILS REPORT PREPARED BY SOCAL GEO PROJ. NO. DATED ON _____ SHOULD BE A PART OF THESE CONTRACT DOCUMENTS.
- B. IF SOILS ARE EXPANSIVE IN NATURE, USE STEEL REINFORCING FOR ALL SITE CONCRETE.
- C. ALL DIMENSIONS ARE TO THE FACE OF CONCRETE WALL, FACE OF CONCRETE CURB OR GRID LINE U.N.O.
- D. SEE "C" PLANS FOR ALL CONCRETE CURBS, GUTTERS AND SWALES. DETAILS ON SHEET AD.1 ARE MINIMUM STANDARDS.
- E. THE ENTIRE PROJECT SHALL BE PERMANENTLY MAINTAINED WITH AN AUTOMATIC IRRIGATION SYSTEM. PRIOR TO INSTALLATION & AT LEAST 60 DAYS BEFORE BLDG. COMPLETION.
- F. SEE "C" DRAWINGS FOR POINT OF CONNECTIONS TO OFF-SITE UTILITIES. CONTRACTOR SHALL VERIFY ACTUAL UTILITY CONTRACTOR SHALL VERIFY ACTUAL UTILITY LOCATIONS.
- G. PROVIDE POSITIVE DRAINAGE AWAY FROM BLDG. SEE "C" DRAWINGS.
- H. CONTRACTOR TO REFER TO "C" DRAWINGS FOR ALL HORIZONTAL CONTROL DIMENSIONS. SITE PLANS ARE FOR GUIDANCE AND STARTING LAYOUT POINTS.
- I. SEE "C" DRAWINGS FOR FINISH GRADE ELEVATIONS.
- J. CONCRETE SIDEWALKS TO BE A MINIMUM OF 4" THICK W/ TOOLED JOINTS AT 6' O.C. EXPANSION/CONSTRUCTION JOINTS SHALL BE A MAXIMUM 12' E.A. WAY W/ 1:20 MAX. SLOPE. EXPANSION JOINTS TO HAVE COMPRESSIVE EXPANSION FILLER MATERIAL OF 1/4". SEE "L" DRAWINGS FOR FINISH.
- K. PAINT CURBS AND PROVIDE SIGNS TO INFORM OF FIRE LINES AS REQUIRED BY FIRE DEPARTMENT.
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- O. LANDSCAPED AREAS SHALL BE DELINEATED WITH A MINIMUM SIX INCHES (6") HIGH CURB.
- P. APPROVED CONCEPTUAL LANDSCAPE PLAN PRIOR TO GRADING PERMIT DEVELOPMENT.

SITE PLAN KEYNOTES

- 1 HEAVY BROOM FINISH CONC. PAVEMENT
- 2 ASPHALT PAVING PER CIVIL
- 3 CONCRETE WALKWAY, MEDIUM BROOM FINISH.
- 4 DRIVEWAY APRONS (DECORATIVE COLORED PAVING) TO BE CONSTRUCTED.
- 5 5'-6"x5'-6"x4" MIN. THICK CONCRETE EXTERIOR LANDING PAD TYP. AT ALL EXTERIOR MAIN DOORS TO LANDSCAPE AREAS. FINISH TO BE MEDIUM BROOM FINISH. SLOPE TO BE 1/4" : 12" MAX. PROVIDE WALK TO PUBLIC WAY OR DRIVE WAY W/ 1:20 MAX. AS REQ. BY CITY INSPECTOR.
- 6 14"H CONCRETE TILT-UP SCREEN WALL
- 7 PROVIDE 8"H TUBE STEEL, MANUALLY OPERATED GATES WITH KNOX-PAD LOCK PER FIRE DEPARTMENT STANDARDS PER DRIVEWAY. GATE TO BE DESIGNED FOR 90 MPH WIND LOAD, EXPOSURE "C". CONTRACTOR TO DESIGN & DETAIL GATES.
- 8 FUTURE GUARD HOUSE
- 9 EXTERIOR LIGHT FIXTURES
- 10 EXTERIOR PARKING LIGHT POLE.
- 11 LANDSCAPE. SEE "L" DWGS. LANDSCAPE AREAS INDICATED BY SHADED PATTERN.
- 12 COVERED TRASH ENCLOSURE E/DAB-A4.1
- 13 BICYCLE RACKS
- 14 OUTDOOR PATIO, EMPLOYEE BREAK AREA, OUTDOOR BREAK AREA NEXT TO POTENTIAL OFFICE TO BE SHADED. SEE TRELIS DETAIL G/DAB-A4.1
- 15 PUMP HOUSE, G/DAB-A4.1
- 16 OUTDOOR RECREATION AREA - HALF BASKETBALL COURT
- 17 8"H WROUGHT IRON FENCE
- 18 WROUGHT IRON SWING GATE FOR FIRE DEPARTMENT ACCESS ONLY. PROVIDE KNOX BOX.
- 19 SMOKING AREA.
- 20 CAFETERIA
- 21 WALKING TRAIL
- 22 CROSSWALK
- 23 EXERCISE ROOM

SITE LEGEND

- LANDSCAPED AREA
- PAVING - SEE "C" DWGS. FOR THICKNESS
- CONCRETE PAVING SEE "C" DWGS. FOR THICKNESS
- PROPERTY LINE
- STANDARD PARKING STALL (9' X 19')
- HANDICAP PARKING STALL (9' X 19')
- PATH OF TRAVEL
- 8"H WROUGHT IRON FENCE
- LIGHT STANDARD
- EXISTING PUBLIC FIRE HYDRANT
- PRIVATE FIRE HYDRANT - APPROXIMATE LOCATION
- FIRE LANE 26'
- CATCH BASIN, APPROX. LOCATION. SEE CIVIL DWGS.
- TRAIL/MAINTENANCE ROAD



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 PERRIS, CA

Consultants:

- CIVIL THIENES
- STRUCTURAL
- MECHANICAL
- PLUMBING
- ELECTRICAL
- LANDSCAPE
- FIRE PROTECTION
- SOILS ENGINEER
- GREGG
- RLA

Title: OVERALL SITE PLAN


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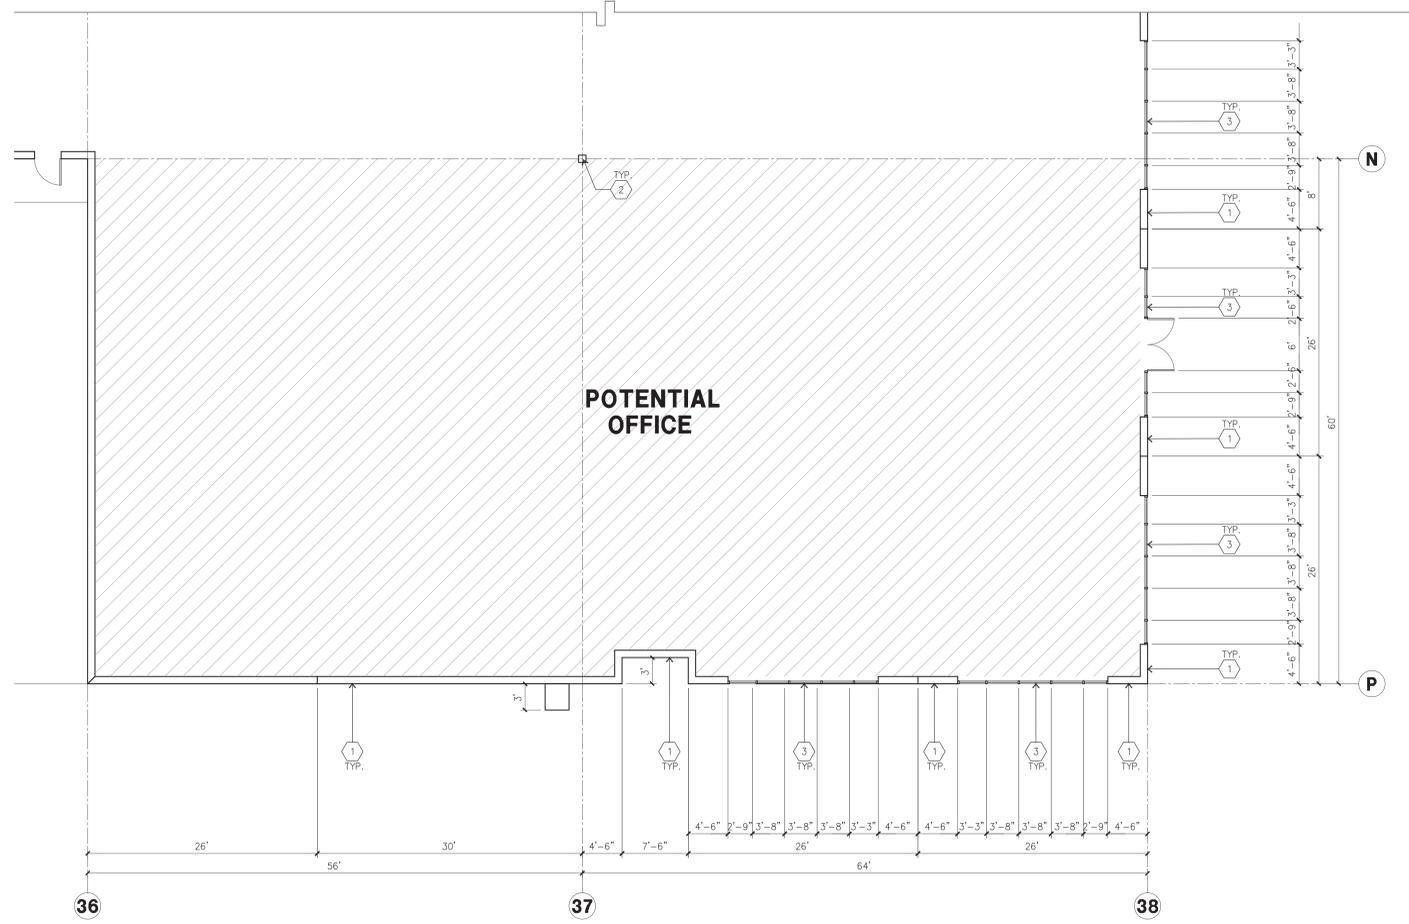
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OVERALL FLOOR PLAN
 scale: 1" = 80'-0"



ENLARGED FLOOR PLAN
 scale: 1/8" = 1'-0"

KEYNOTES - FLOOR PLAN

- 1 CONCRETE TILT-UP PANEL.
- 2 STRUCTURAL STEEL COLUMN.
- 3 TYPICAL STOREFRONT SYSTEM WITH GLAZING. SEE OFFICE BLOW-UP AND ELEVATIONS FOR SIZE, COLOR AND LOCATIONS.
- 4 CONCRETE RAMP
- 5 5'-6"x5"x4" THICK CONCRETE EXTERIOR LANDING PAD TYPICAL AT ALL EXTERIOR MAN DOORS TO LANDSCAPED AREA. FINISH TO BE MEDIUM BROOM FINISH. PROVIDE WALK TO HARD SURFACE PER CITY REQUIREMENTS.
- 6 9'x10' TRUCK DOOR, VERTICAL LIFT, STANDARD GRADE.
- 7 12'x14' DRIVE THRU, VERTICAL LIFT, STANDARD GRADE.
- 8 3'x7' HOLLOW METAL EXTERIOR MAN DOOR.
- 9 SOFFIT ABOVE
- 10 ROOF ACCESS LADDER
- 11 CONC. FILLED GUARD POST. 6" DIA. UNO 42"H.
- 12 INTERIOR ROOF DRAIN WITH OVERFLOW SCUPPER
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- 14 EXTERIOR CONCRETE STAIR
- 15 DOCK BUMPER
- 16 METAL LOUVER
- 17 CAFETERIA
- 18 EXERCISE ROOM

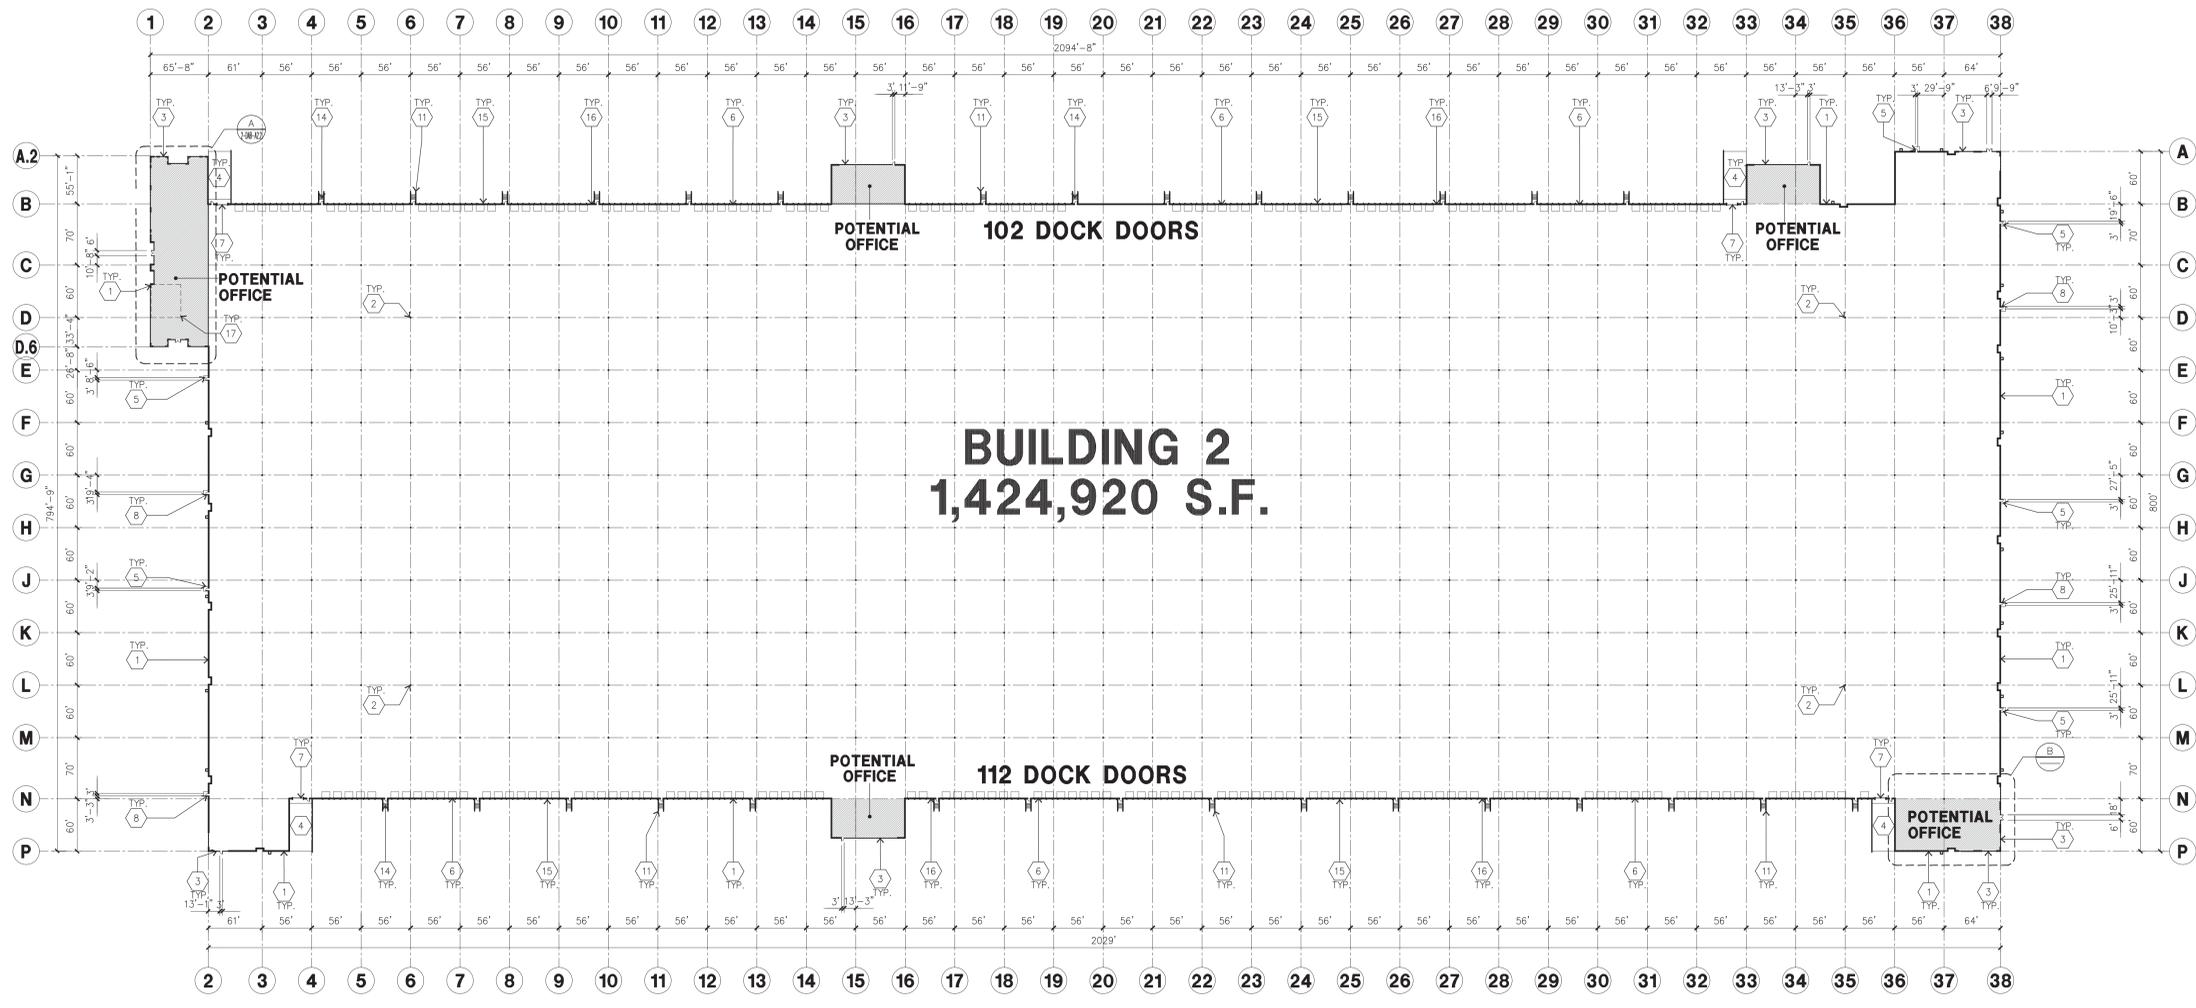GENERAL NOTES - FLOOR PLAN

- A. THIS BUILDING IS DESIGNED FOR HIGH PILE STORAGE WITH FIRE ACCESS MAN DOORS AT 100' MAXIMUM O.C. A SEPERATE PERMIT WILL BE REQUIRED FOR ANY RACKING/CONVEYER SYSTEMS.
- B. FIRE HOSE LOCATIONS SHALL BE APPROVED PER FIRE DEPARTMENT.
- C. THE BUILDING FLOOR SLAB SLOPES 1/2%", SEE "C" DRAWINGS FOR FINISH SURFACE ELEVATIONS.
- D. FLOOR SLAB SHALL BE SEALED WITH LAPOLIDITH MANUFACTURER: SONOBORN) OR APPROVED EQUAL.
- E. WAREHOUSE INTERIOR CONCRETE WALLS ARE PAINTED WHITE. COLUMNS ARE TO RECIEVE GREY PRIMER ONLY. ALL GYP. BD. WALLS IN WAREHOUSE TO RECEIVE 1 COAT OF WHITE TO COVER.
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MECHANICAL	-
PLUMBING	-
ELECTRICAL	GREGG
LANDSCAPE	RLA
FIRE PROTECTION	-
SOILS ENGINEER	-

Title: **OVERALL FLOOR PLAN**

Project Number: 19214
 Drawn by: CR
 Date: 07/16/21
 Revision:

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2-DAB-A2.1

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Title: ENLARGED FLOOR PLAN

Project Number: 19214


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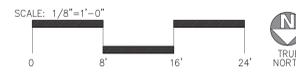
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ENLARGED FLOOR PLAN
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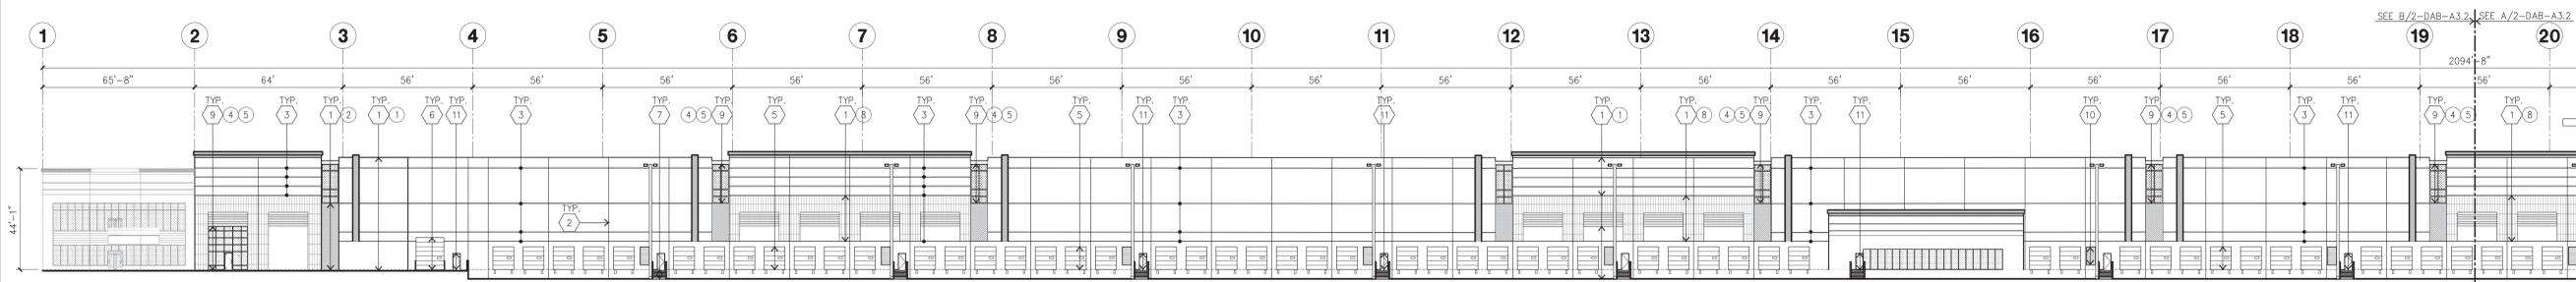


KEYNOTES - FLOOR PLAN


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GENERAL NOTES - FLOOR PLAN


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EAST ELEVATION
scale: 1" = 30'-0"

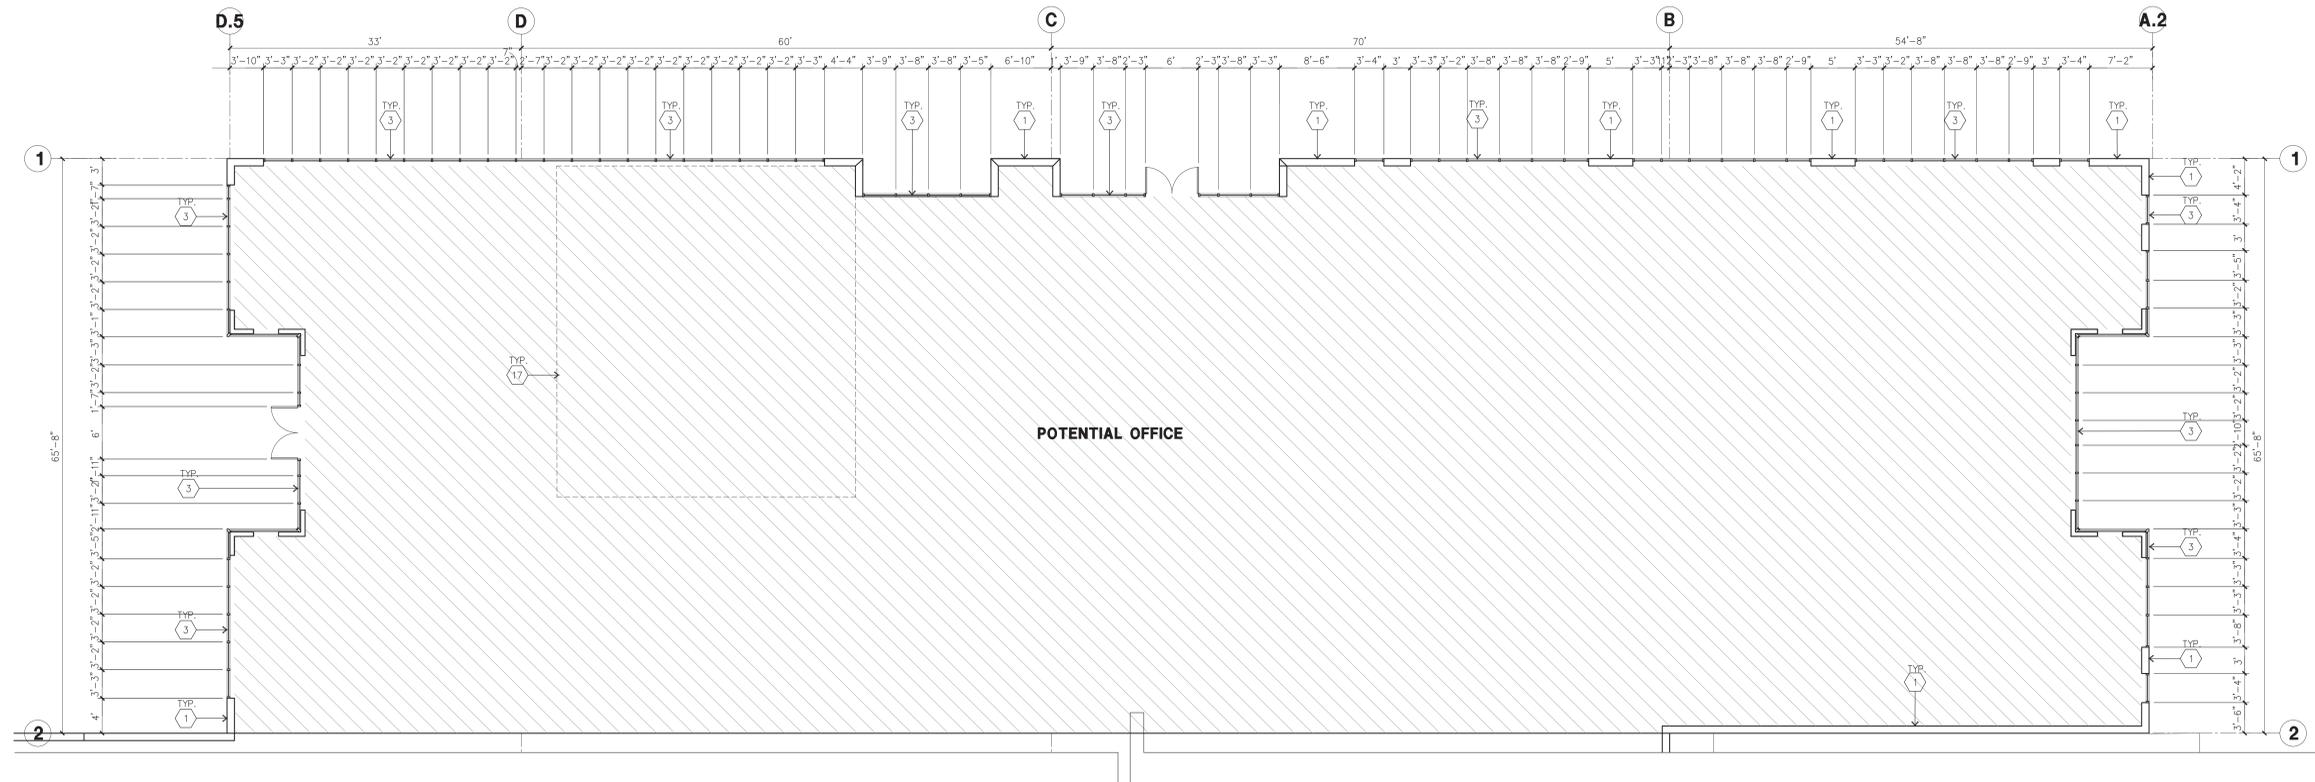

EAST ELEVATION CONT'
scale: 1" = 30'-0"

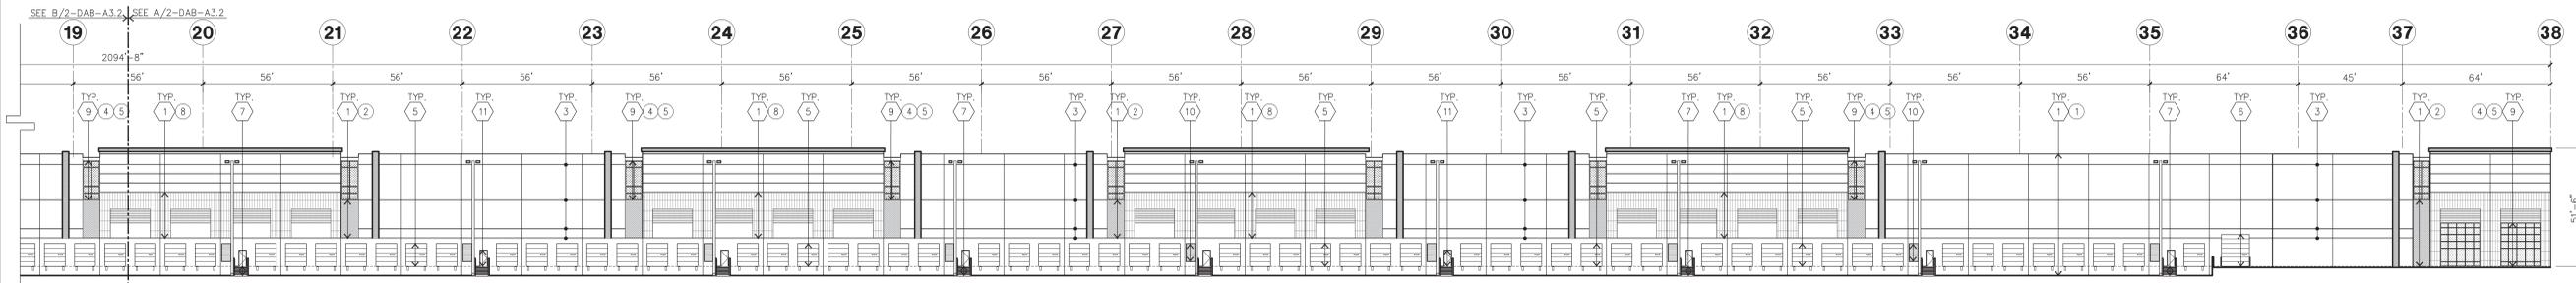

SOUTH ELEVATION CONT'
scale: 1/8" = 1'-0"

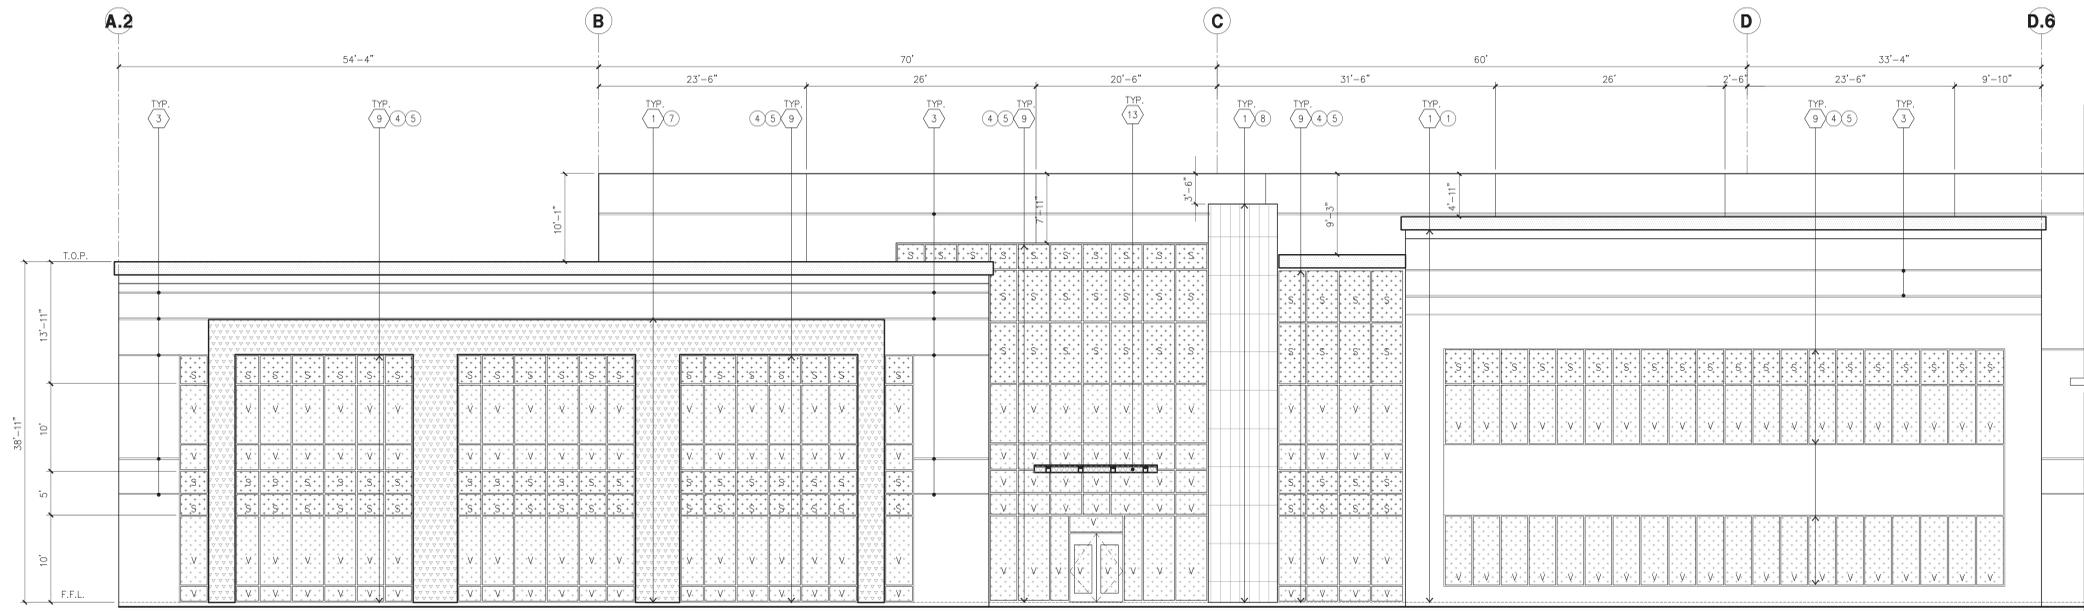KEYNOTES - ELEVATIONS

- 1 CONCRETE TILT-UP PANEL (PAINTED).
- 2 PANEL JOINT.
- 3 PANEL REVEAL.
- 4 CONCRETE TILT-UP SCREEN WALL.
- 5 OVERHEAD DOOR @ DOCK HIGH.
- 6 OVERHEAD DOOR @ DRIVE THRU.
- 7 CONCRETE STAIR, LANDING AND CONC. GUARDRAIL.
- 8 DOCK BUMPER.
- 9 ALUMINUM STOREFRONT FRAMING W/ TEMPERED GLAZING AT ALL DOORS. SIDELITES ADJACENT TO DOORS AND GLAZING W/ BOTTOMS LESS THAN 18" ABOVE F.F. ELEVATION.
- 10 LOUVER (SIZE AND LOCATION APPROX. ONLY).
- 11 HOLLOW METAL DOORS.
- 12 INTERIOR ROOF DRAIN WITH OVERFLOW SCUPPER.
- 13 EXTERIOR CANOPY.

GENERAL NOTES - ELEVATIONS


- A. ALL PAINT COLOR CHANGES TO OCCUR AT INSIDE CORNERS UNLESS NOTED OTHERWISE.
- B. ALL PAINT FINISHES ARE TO BE FLAT UNLESS NOTED OTHERWISE.
- C. T.O.P. = TOP OF PARAPET - ELEVATION.
- D. F.F. = FINISH FLOOR ELEVATION.
- E. STOREFRONT CONSTRUCTION: GLASS, METAL ATTACHMENTS AND LINTELS SHALL BE DESIGNED TO RESIST 90 MPH EXPOSURE "C" WINDS. CONTRACTOR SHALL SUBMIT SHOP DRAWINGS PRIOR TO INSTALLATION.
- F. CONTRACTOR SHALL FULLY PAINT ONE CONCRETE PANEL W/ SELECTED COLORS. ARCHITECT AND OWNER SHALL APPROVE PRIOR TO PAINTING REMAINDER OF BUILDING.

COLOR SCHEDULE - ELEVATIONS

- 1 PAINT, COLOR : SW 7005 PURE WHITE
- 2 PAINT, COLOR : SW 7071 GRAY SCREEN
- 3 PAINT, COLOR : SW 7072 ONLINE
- 4 MULLIONS COLOR : CLEAR ANODIZED
- 5 GLAZING COLOR : BLUE REFLECTIVE
- 6 METAL CANOPY : STEEL CANOPY P1 WITH CLEAR RESIN TOP
- 7 PAINT, COLOR : ANATOLIA ERAMOSA COLOR: CARBON
- 8 PAINT, COLOR : ANATOLIA ERAMOSA COLOR: ICE

GLAZING LEGEND

- NOTE: ALL EXTERIOR AND INTERIOR GLAZING SHALL BE TEMPERED.
- TEMPERED VISION GLASS TEMPERED SPANDREL GLASS
- ALL GLASS TO BE NON-REFLECTIVE
- V : VISION GLASS
1/4" VISTACOOOL PACIFICA
- S : SPANDREL WITH CONCRETE BEHIND
1/4" VISTACOOOL PACIFICA WITH WARM GRAY OPACICOAT PAINTED ON REFLECTIVE. INSTALLED ON CONCRETE.
- MULLIONS : ANODIZED CLEAR

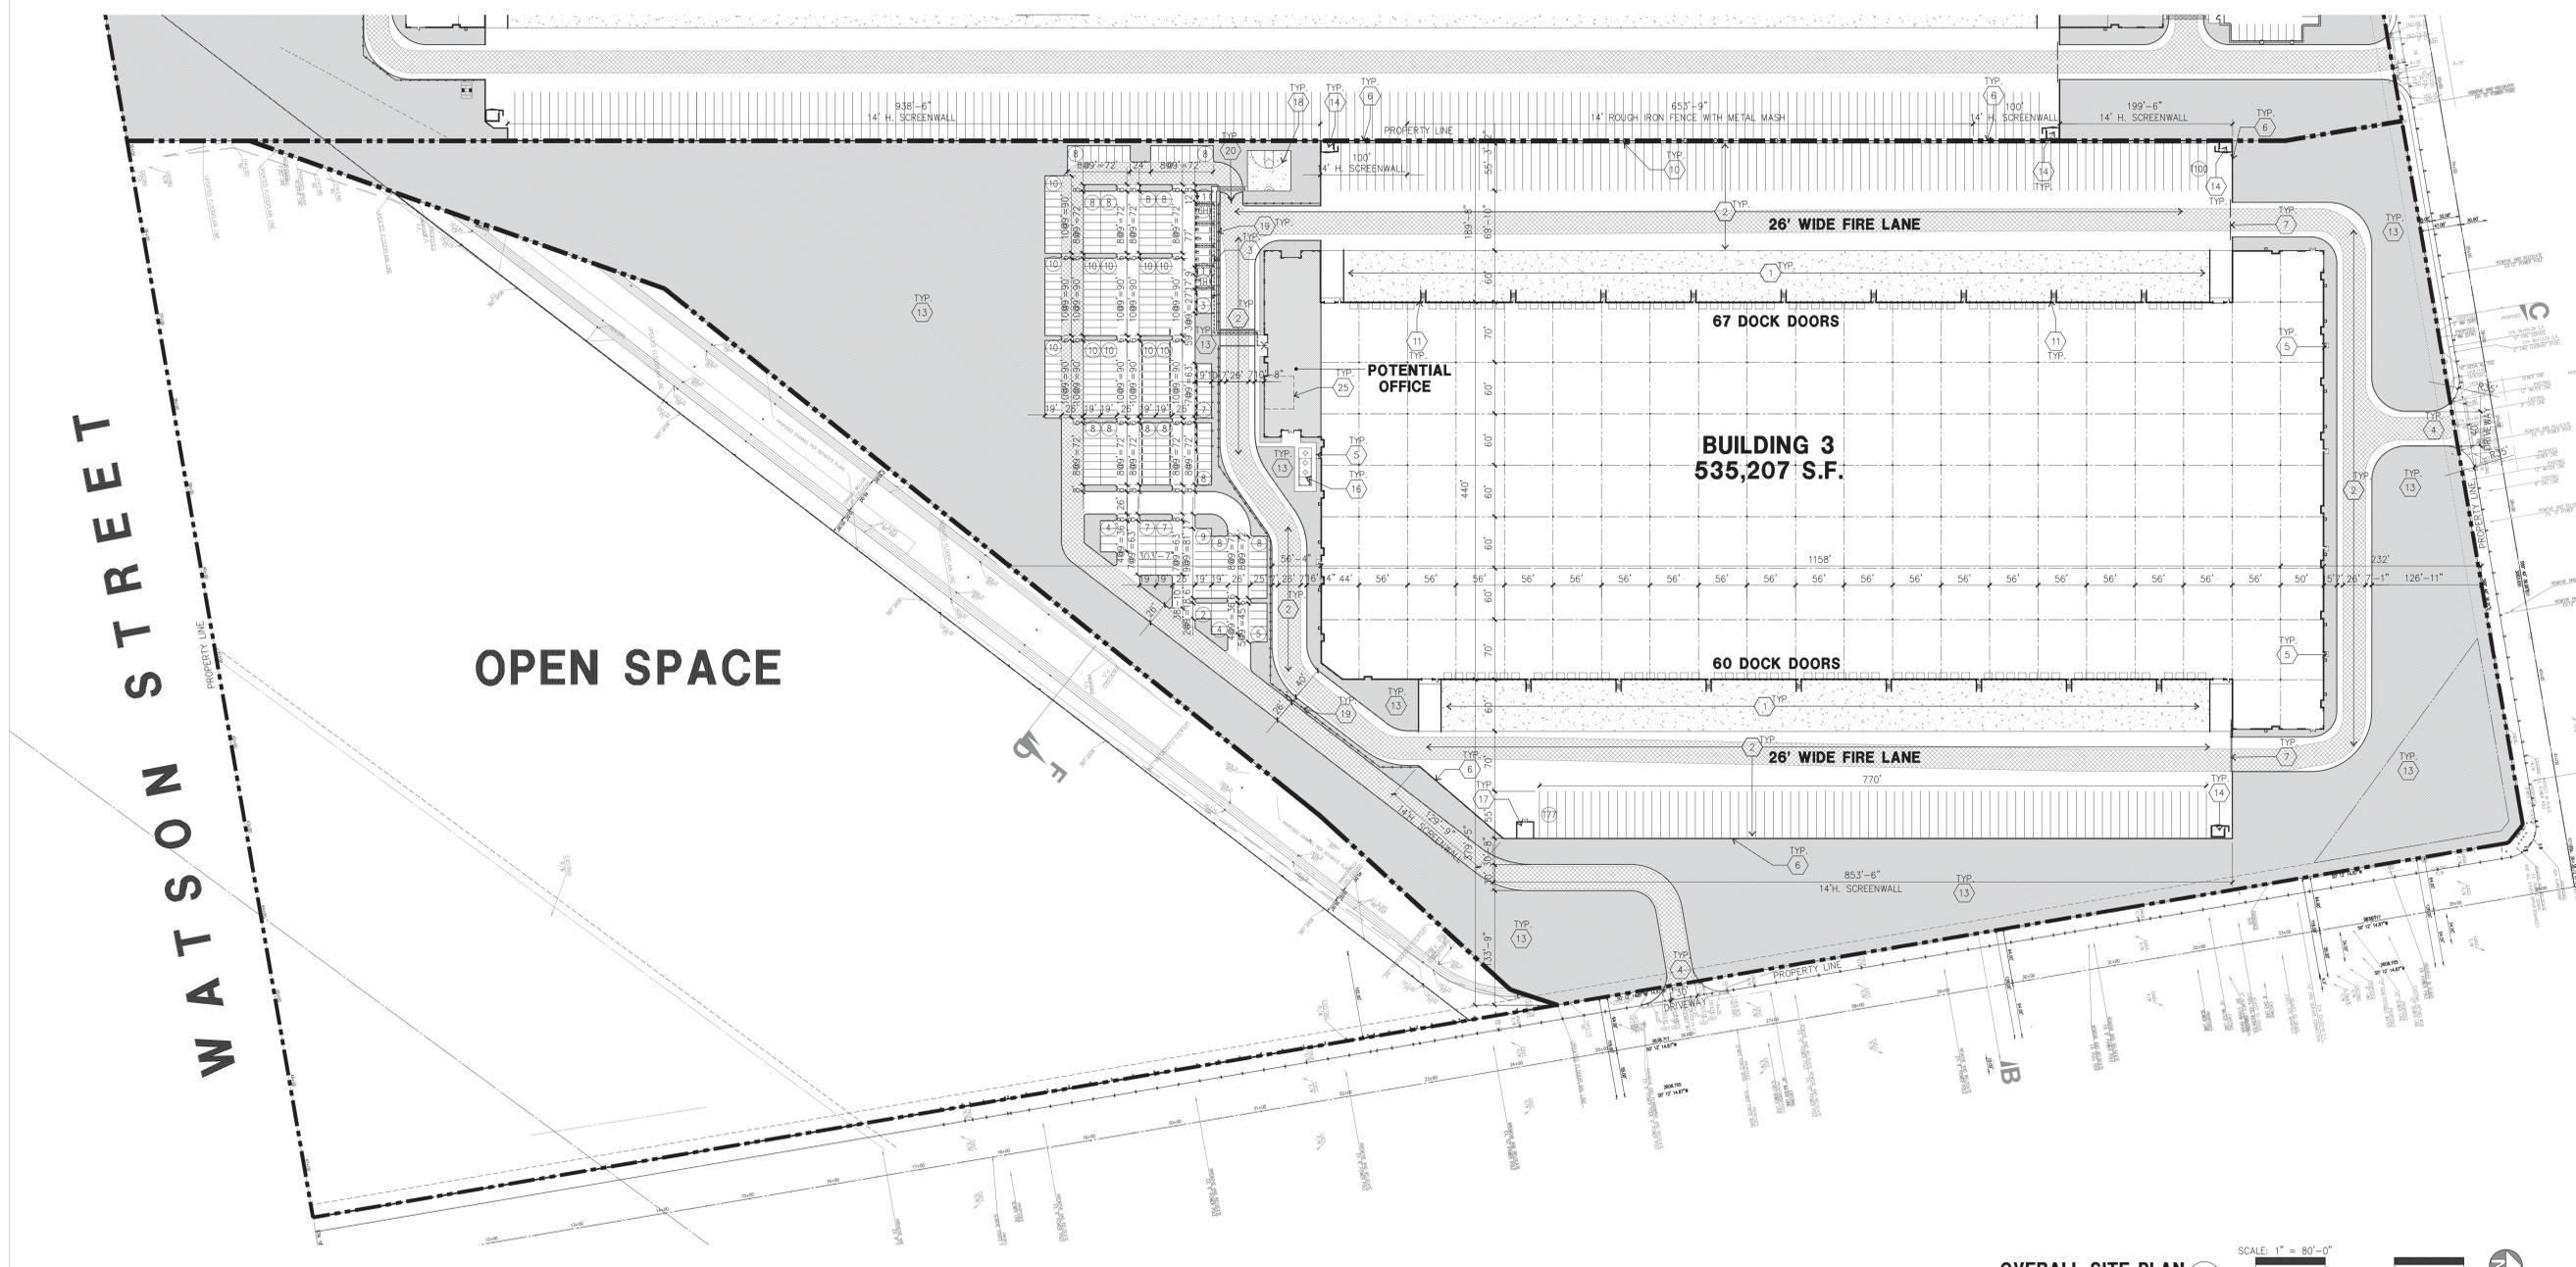

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LICENSED ARCHITECT
N.W.M.
C-29451
3-31-23
RENEWAL
DATE
STATE OF CALIFORNIA

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Title: **OVERALL SITE PLAN**

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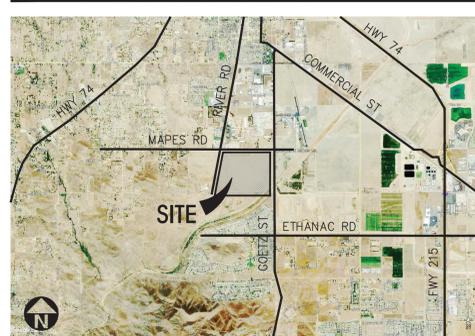
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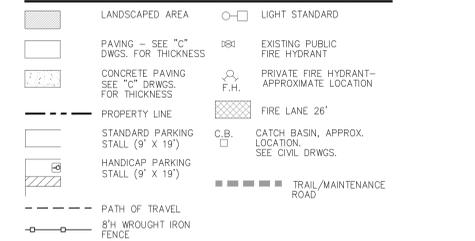
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- 11 LANDSCAPE. SEE "L" DWGS. LANDSCAPE AREAS INDICATED BY SHADED PATTERN.
- 12 COVERED TRASH ENCLOSURE E/DAB-A4.1
- 13 BICYCLE RACKS
- 14 OUTDOOR PATIO, EMPLOYEE BREAK AREA, OUTDOOR BREAK AREA NEXT TO POTENTIAL OFFICE TO BE SHADED. SEE TRELIS DETAIL G/DAB-A4.1
- 15 PUMP HOUSE, G/DAB-A4.1
- 16 OUTDOOR RECREATION AREA - HALF BASKETBALL COURT
- 17 8"H WROUGHT IRON FENCE
- 18 WROUGHT IRON SWING GATE FOR FIRE DEPARTMENT ACCESS ONLY. PROVIDE KNOX BOX.
- 19 SMOKING AREA.
- 20 CAFETERIA
- 21 WALKING TRAIL
- 22 CROSSWALK
- 23 EXERCISE ROOM
- 14 LIGHT STANDARD
- 1881 EXISTING PUBLIC FIRE HYDRANT
- F.H. PRIVATE FIRE HYDRANT- APPROXIMATE LOCATION
- FIRE LANE 26'
- C.B. CATCH BASIN, APPROX. LOCATION. SEE CIVIL DWGS.
- TRAIL/MAINTENANCE ROAD

VICINITY MAP



SITE LEGEND



PROJECT DATA

	BLDG. 1	BLDG. 2	BLDG. 3 SUB-TOTAL	OPEN SPACE	TOTAL
SITE AREA	1,818,488	7,247,856	1,108,032	8,353,368 s.f.	
Acres	41.5	160.3	24.3	186.1	
BUILDING AREA					
Office	30,000	30,000	10,000	50,000	50,000 s.f.
Warehouse	450,000	450,000	535,207	3,345,217	3,345,217 s.f.
TOTAL	480,000	480,000	535,207	3,345,217	3,345,217 s.f.
CLEAR HEIGHT	32'	32'	40'		
COVERAGE	35.9%	31.0%	33.1%	46.2%	40.0%
AUTO PARKING REQUIRED					
Office (office area is less than 10%)					
Whse: 1st 20K @ 111,000 s.f.	20	20	20	60	60 stalls
2nd 20K @ 112,000 s.f.	10	10	10	30	30 stalls
above 40K @ 116,000 s.f.	100	100	100	407	407 stalls
TOTAL	130	130	130	737	737 stalls
AUTO PARKING PROVIDED					
Standard (8' x 19')	85	85	207	857	957 stalls
Standard Accessible Parking (8' x 19')	5	5	5	20	20 stalls
Van Accessible Parking (12' x 19')	2	2	2	6	6 stalls
EV/CS (8' x 19')	14	14	14	61	61 stalls
EV Capable (8' x 19')	41	41	41	181	181 stalls
Standard EV ADA (8' x 19')	1	1	1	3	3 stalls
VAN EV (12' x 19')	1	1	1	3	3 stalls
Amberatory (11' x 19')	0	0	0	1	1 stall
TOTAL	169	169	271	1,232	1,232 stalls
TRAILER PARKING REQUIRED					
Trailer: 15,000 SF	108	108	108	671	671 stalls
TRAILER PARKING PROVIDED					
Trailer (10' x 55')	131	131	131	786	786 stalls
ZONING ORDINANCE FOR CITY					
Zoning Designation - General Industrial					
MAXIMUM BUILDING HEIGHT ALL OVERD					
Height - 50'					
MAXIMUM FLOOR AREA RATIO					
PAR - 75%					
LANDSCAPE REQUIREMENT					
Price Range - 12'					
LANDSCAPE PROVIDED	476713	450173	464309		
	16.8%	16.1%	30.6%		
SETBACKS					
Building					
Mapes St. - 10' (Local)					
Coetz St. - 15' (Arterial)					
A Street - 10' (Local)					
Side/Rear - none, adjoining R zone-20'					




OFFICIAL USE ONLY

KEYNOTES - FLOOR PLAN



- 1 CONCRETE TILT-UP PANEL.
- 2 STRUCTURAL STEEL COLUMN.
- 3 TYPICAL STOREFRONT SYSTEM WITH GLAZING. SEE OFFICE BLOW-UP AND ELEVATIONS FOR SIZE, COLOR AND LOCATIONS.
- 4 CONCRETE RAMP
- 5 5'-6"x5"x4" THICK CONCRETE EXTERIOR LANDING PAD TYPICAL AT ALL EXTERIOR MAN DOORS TO LANDSCAPED AREA. FINISH TO BE MEDIUM BROOM FINISH. PROVIDE WALK TO HARD SURFACE PER CITY REQUIREMENTS.
- 6 9'x10' TRUCK DOOR, VERTICAL LIFT, STANDARD GRADE.
- 7 12'x14' DRIVE THRU, VERTICAL LIFT, STANDARD GRADE.
- 8 3'x7' HOLLOW METAL EXTERIOR MAN DOOR.
- 9 SOFFIT ABOVE
- 10 ROOF ACCESS LADDER
- 11 CONC. FILLED GUARD POST. 6" DIA. UNO 42"H.
- 12 INTERIOR ROOFDRAIN WITH OVERFLOW SCUPPER
- 13 EMPLOYEE AMENITIES: BREAK ROOM & COFFEE BAR W/INTERNET ACCESS
- 14 EXTERIOR CONCRETE STAIR
- 15 DOCK BUMPER
- 16 METAL LOUVER
- 17 CAFETERIA
- 18 EXERCISE ROOM

GENERAL NOTES - FLOOR PLAN


- A. THIS BUILDING IS DESIGNED FOR HIGH PILE STORAGE WITH FIRE ACCESS MAN DOORS AT 100' MAXIMUM O.C. A SEPERATE PERMIT WILL BE REQUIRED FOR ANY RACKING/CONVEYER SYSTEMS.
- B. FIRE HOSE LOCATIONS SHALL BE APPROVED PER FIRE DEPARTMENT.
- C. THE BUILDING FLOOR SLAB SLOPES 1/2% SEE "C" DRAWINGS FOR FINISH SURFACE ELEVATIONS.
- D. FLOOR SLAB SHALL BE SEALED WITH LAPOLIDITH MANUFACTURER: SONOBORN) OR APPROVED EQUAL.
- E. WAREHOUSE INTERIOR CONCRETE WALLS ARE PAINTED WHITE. COLUMNS ARE TO RECEIVE GREY PRIMER ONLY. ALL GYP. BD. WALLS IN WAREHOUSE TO RECEIVE 1 COAT OF WHITE TO COVER.
- F. SLOPE POUR STRIP 1/2" TO EXTERIOR AT ALL PERSONAL EXITS. SEE "S" DRAWINGS FOR POUR STRIP LOCATION.
- G. ALL DIMENSIONS ARE TO THE FACE OF CONCRETE PANEL WALL, GRIDLINE, OR FACE OF STUD U.N.O.
- H. SEE CIVIL DRAWINGS FOR POINT OF CONNECTIONS TO OFF-SITE UTILITIES. CONTRACTOR TO VERIFY ACTUAL UTILITY LOCATIONS.
- I. FOR DOOR TYPES AND SIZES, SEE DETAIL SHEET AD.4. NOTE: ALL DOORS PER DOOR SCHEDULE ARE FINISH OPENINGS.
- J. CONTRACTOR TO PROTECT AND KEEP THE FLOOR SLAB CLEAN. ALL EQUIPMENT TO BE DIAPERED INCLUDING CARS AND TRUCKS.

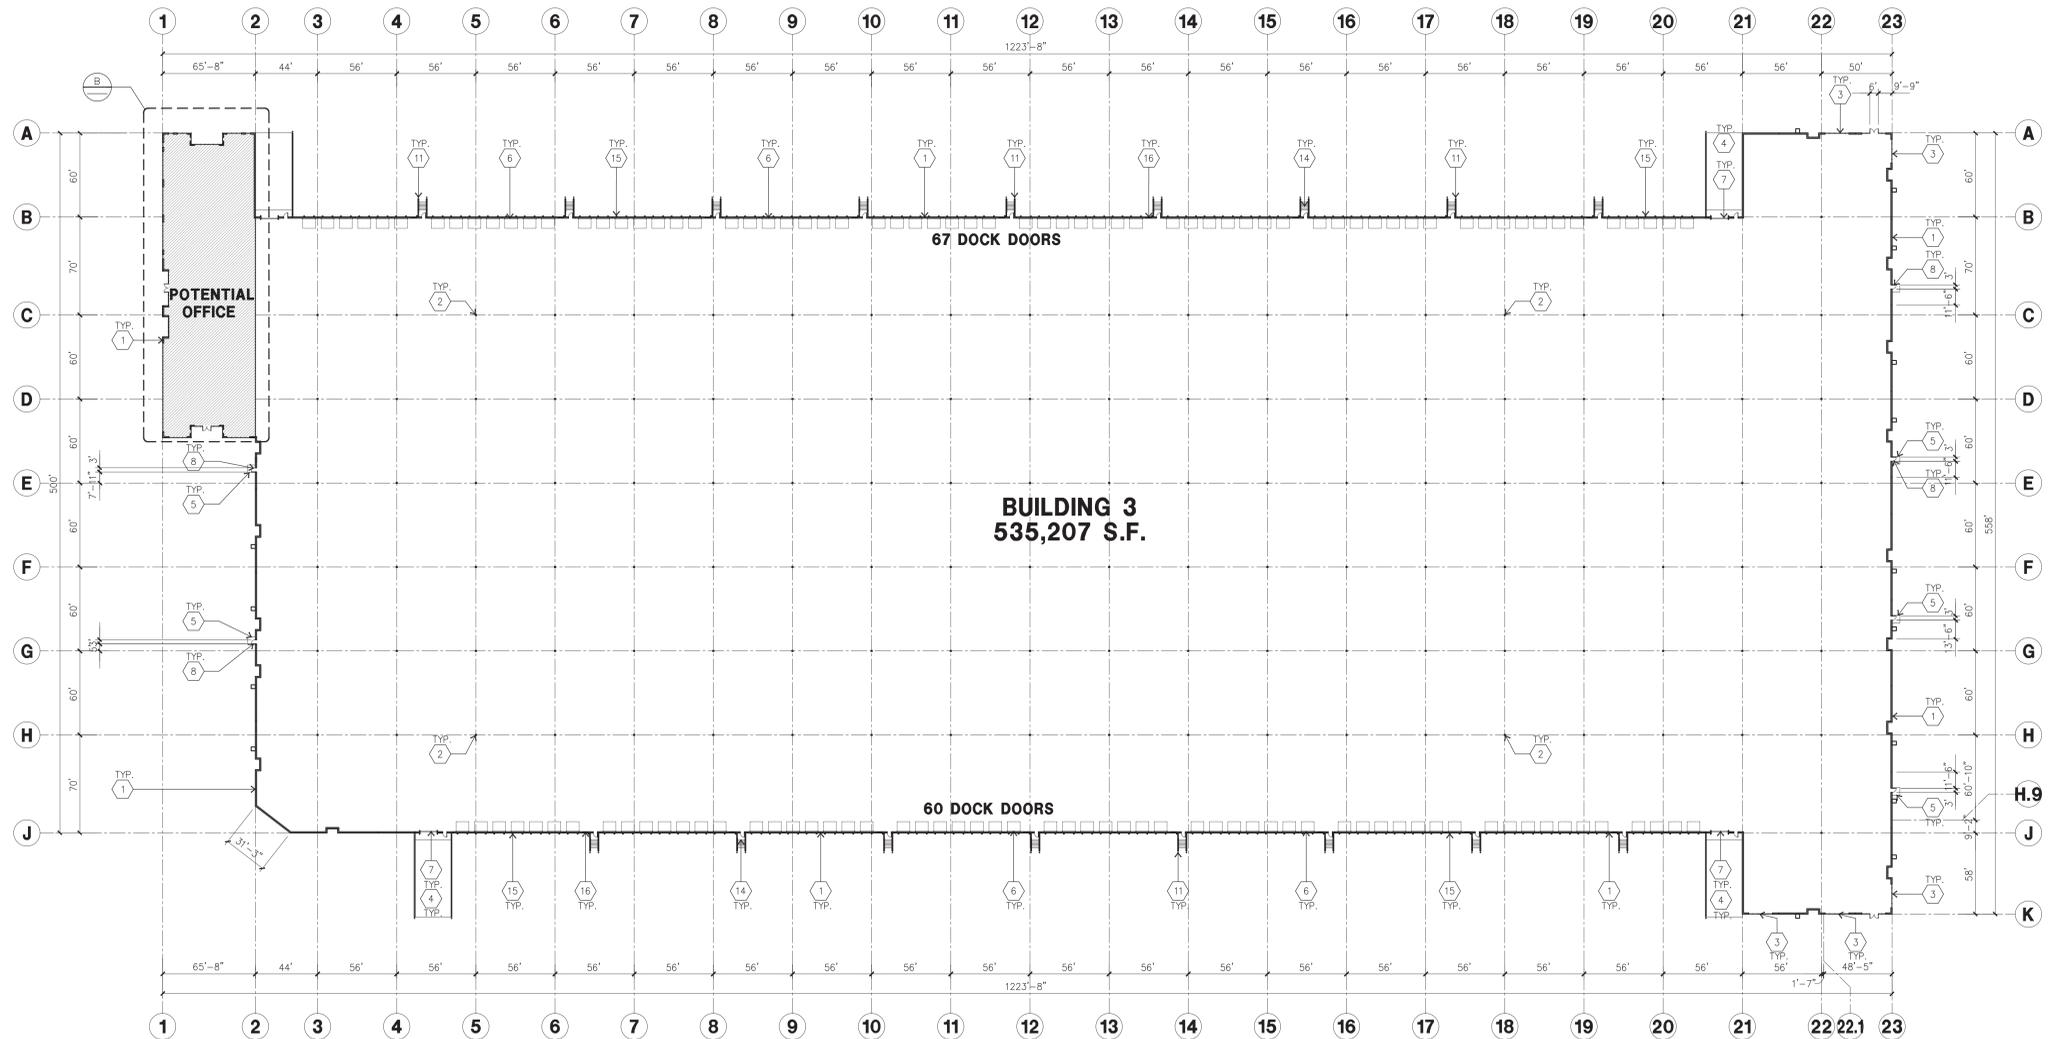

OVERALL FLOOR PLAN
scale: 1" = 50'-0"

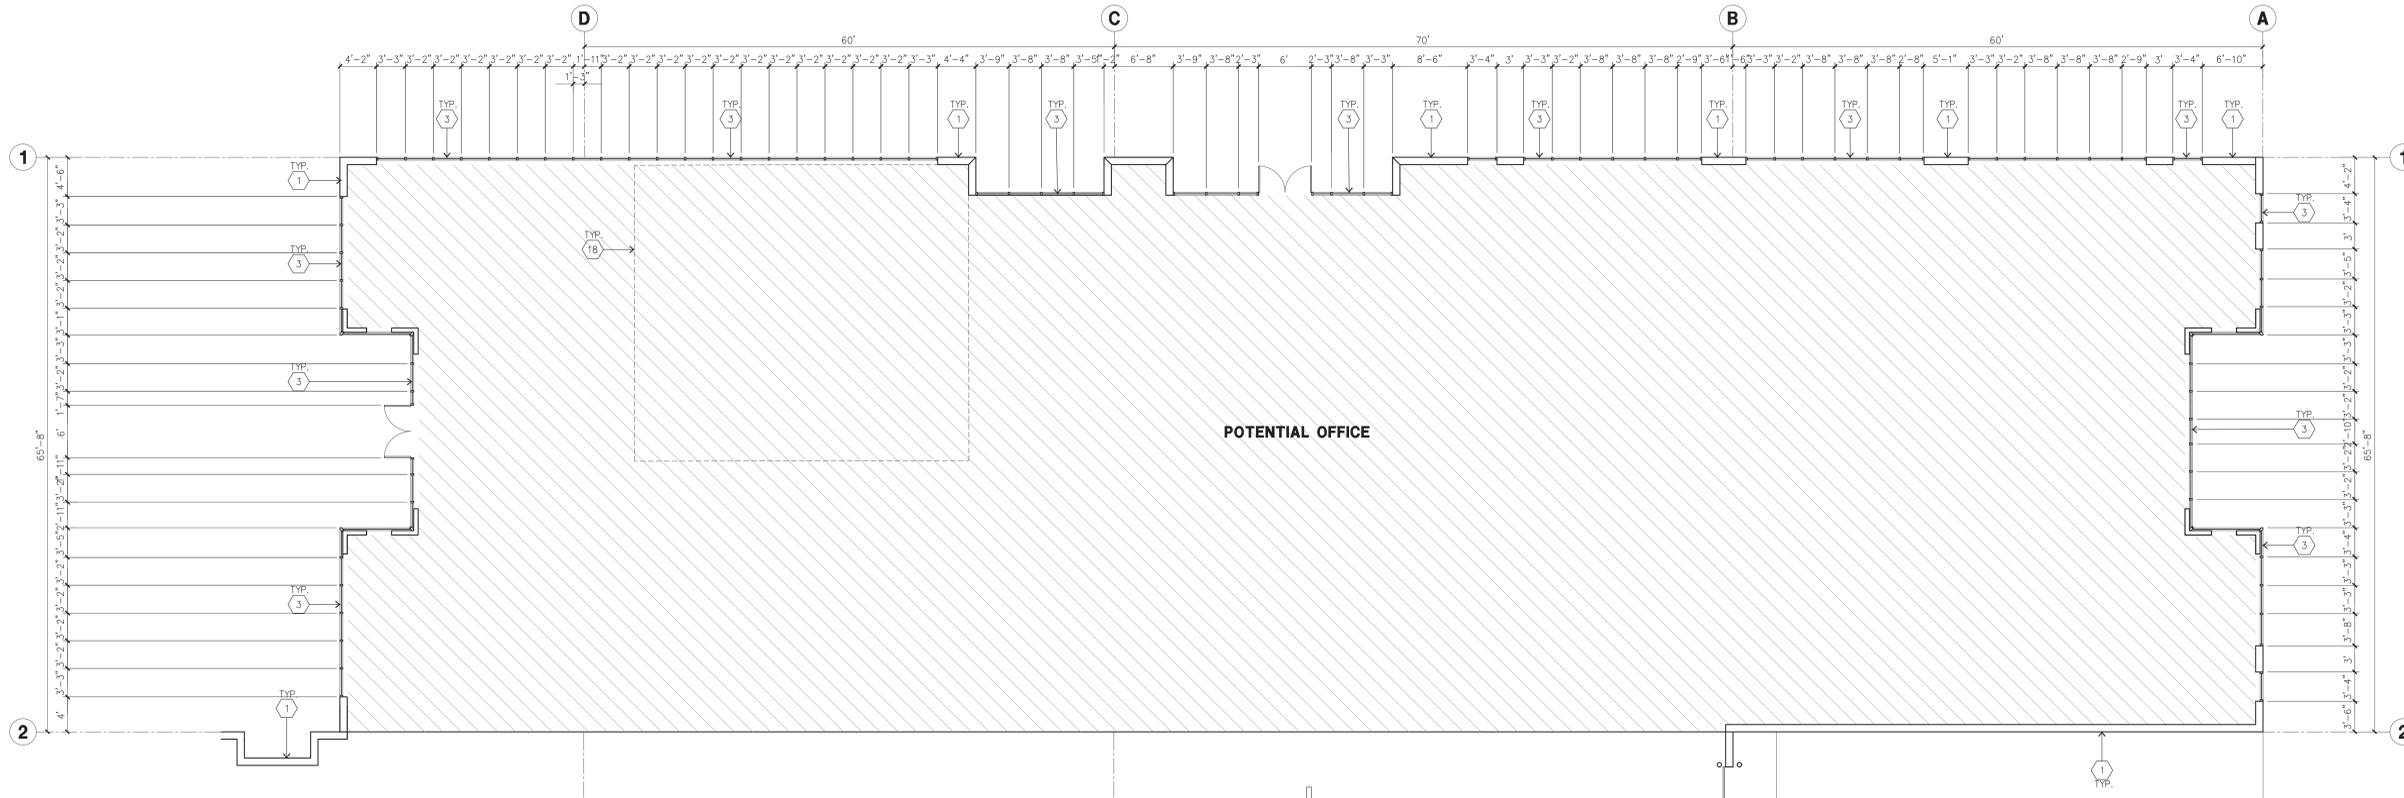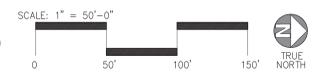

ENLARGED FLOOR PLAN
scale: 1/8"=1'-0"

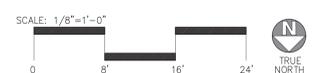

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Project:
PERRIS LOGISTIC CENTER SOUTH

MAPES ST. & A ST.
PERRIS, CA

Consultants:


CIVIL	THIENES
STRUCTURAL	-
MECHANICAL	-
PLUMBING	-
ELECTRICAL	GREGG
LANDSCAPE	RLA
FIRE PROTECTION	-
SOILS ENGINEER	-

Title: OVERALL FLOOR PLAN


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Drawn by: CR
Date: 07/16/21
Revision:

Sheet:


3-DAB-A2.1

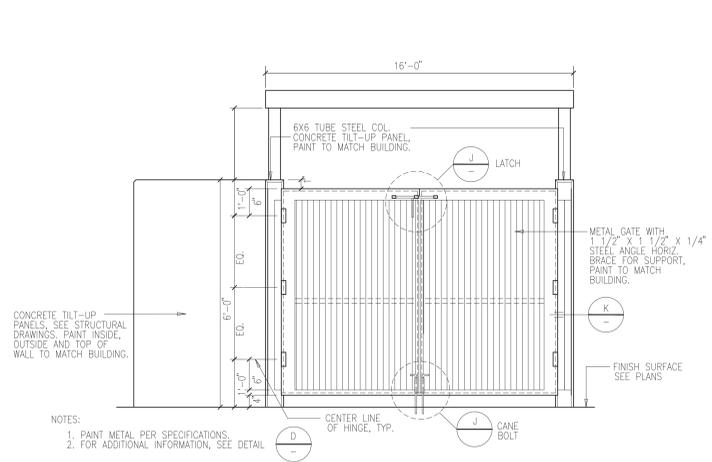


TRASH ENCLOSURE GATE ELEVATION D
scale: 1/2" = 1'-0"

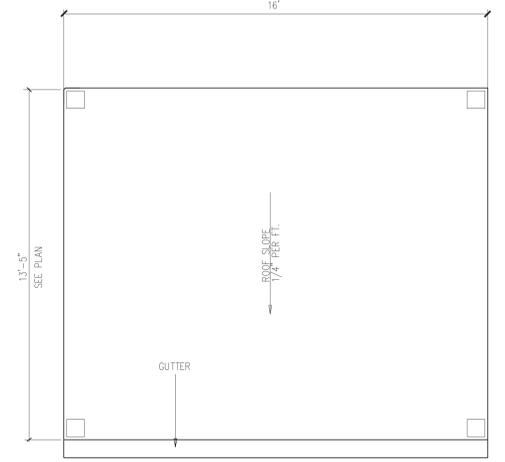


TRASH ENCLOSURE ROOF PLAN C
scale: 1/2" = 1'-0"

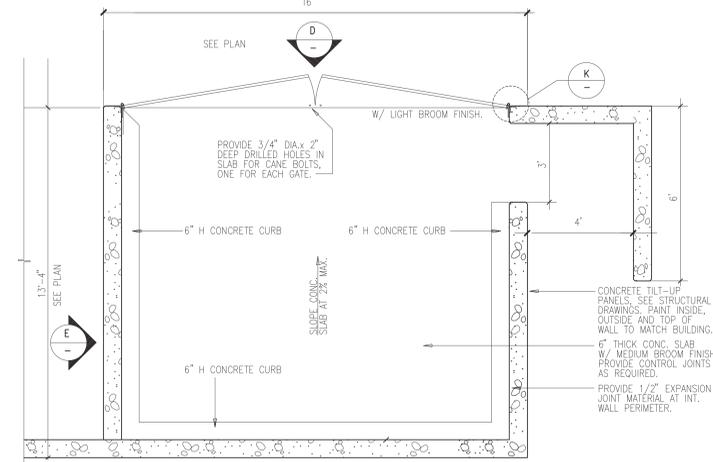


TRASH ENCLOSURE PLAN B
scale: 1/2" = 1'-0"

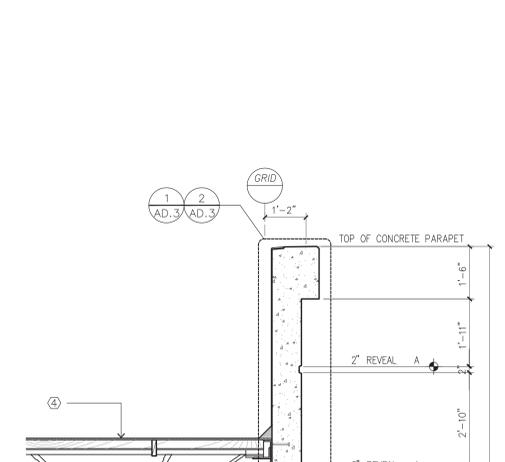


TYP. STOREFRONT ELEVATION A
scale: 1/2" = 1'-0"

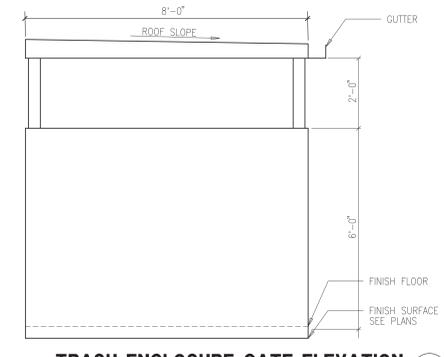


TRASH ENCLOSURE GATE ELEVATION E
scale: 1/2" = 1'-0"

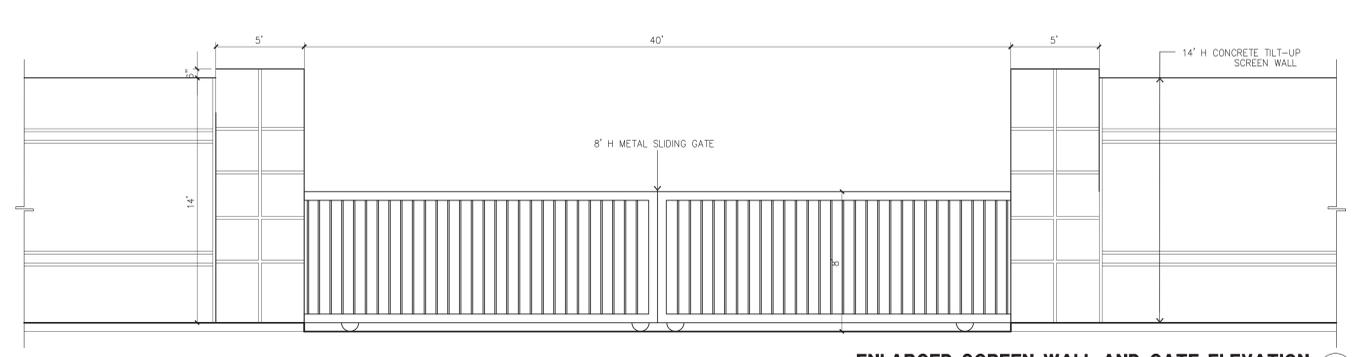


ENLARGED SCREEN WALL AND GATE ELEVATION F
scale: 1/4" = 1'-0"

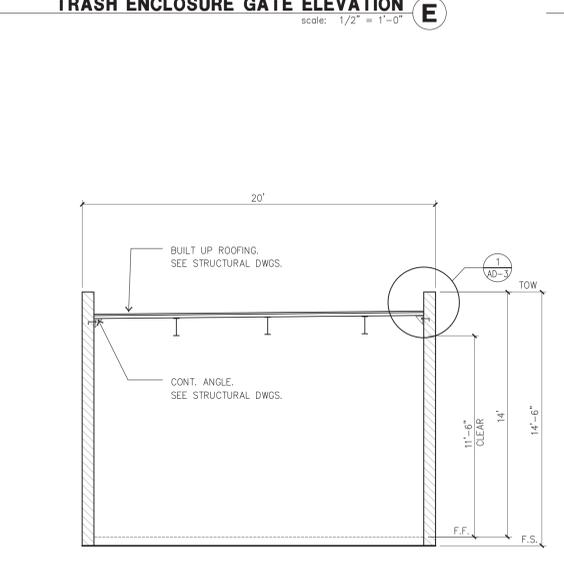


PUMP HOUSE SECTION J
scale: 1/4" = 1'-0"

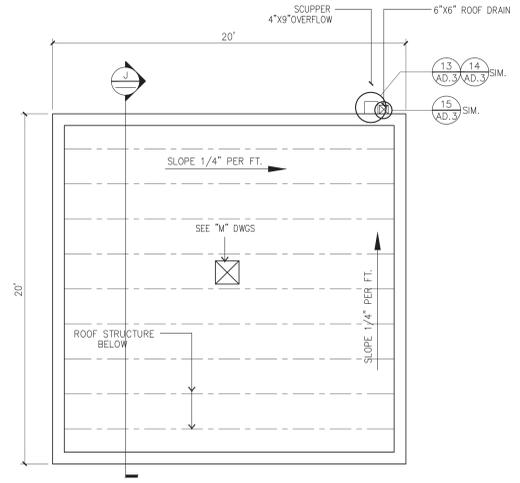


PUMP HOUSE ROOF PLAN H
scale: 1/4" = 1'-0"

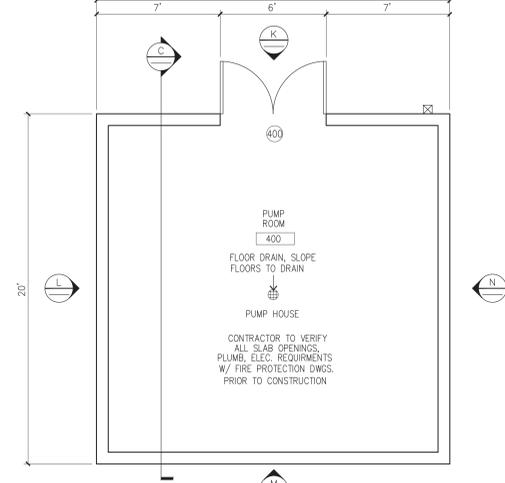


PUMP HOUSE FLOOR PLAN G
scale: 1/4" = 1'-0"

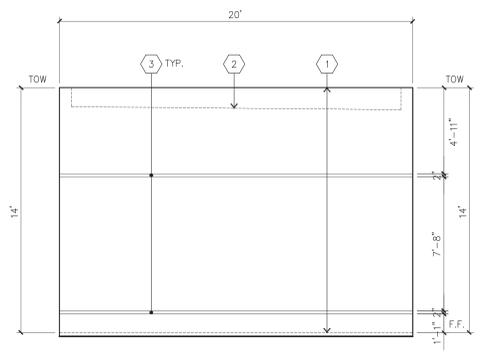


EAST ELEVATION N
scale: 1/4" = 1'-0"

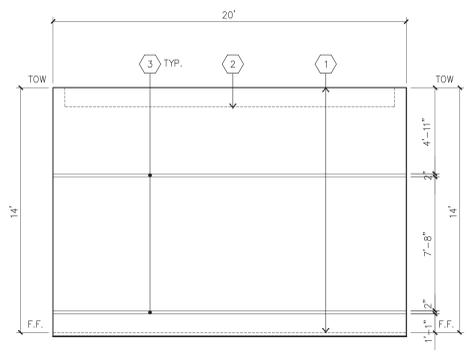

SOUTH ELEVATION M
scale: 1/4" = 1'-0"

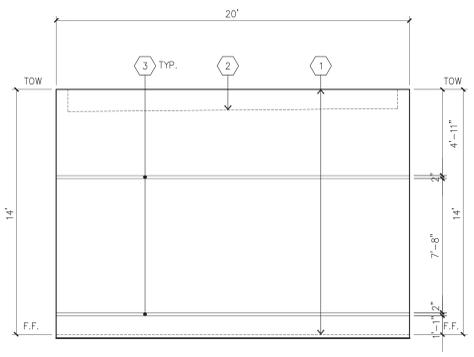

WEST ELEVATION L
scale: 1/4" = 1'-0"

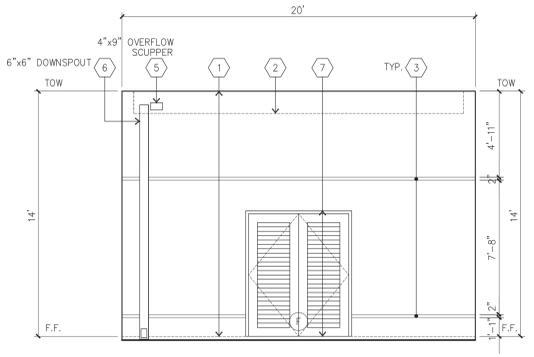

NORTH ELEVATION K
scale: 1/4" = 1'-0"